

ATTACHMENTS DISTRIBUTED UNDER SEPARATE COVER

6.1 PV 17/10/23 – 61 GRINSELL STREET KOTARA - SEC 4.55(1A) MODIFICATION TO DA2021/00662

Dwelling house including secondary dwelling, ancillary structures (pool and retaining walls) and demolition of existing structures - changes to design - MA2022/00336

Attachment A Submitted Plans

6.2 PV 17/10/23 – 2/29 AND 3/31 HONEYSUCKLE DRIVE NEWCASTLE

Food and drink premises - change of use and fitout - DA2023/00243

Attachment A Submitted Plans




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ATTACHMENTS DISTRIBUTED UNDER SEPARATE COVER

PV 17/10/23 – 61 GRINSELL STREET KOTARA –
SEC 4.55(1A) MODIFICATION TO DA2021/00662 - DWELLING
HOUSE INCLUDING SECONDARY DWELLING, ANCILLARY
STRUCTURES (POOL AND RETAINING WALLS) AND DEMOLITION
OF EXISTING STRUCTURES - CHANGES TO DESIGN MA2022/00336

6.1 Attachment A: Submitted Plans

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SECTION 4.55 MODIFICATION

EROSION AND SEDIMENT CONTROL NOTES

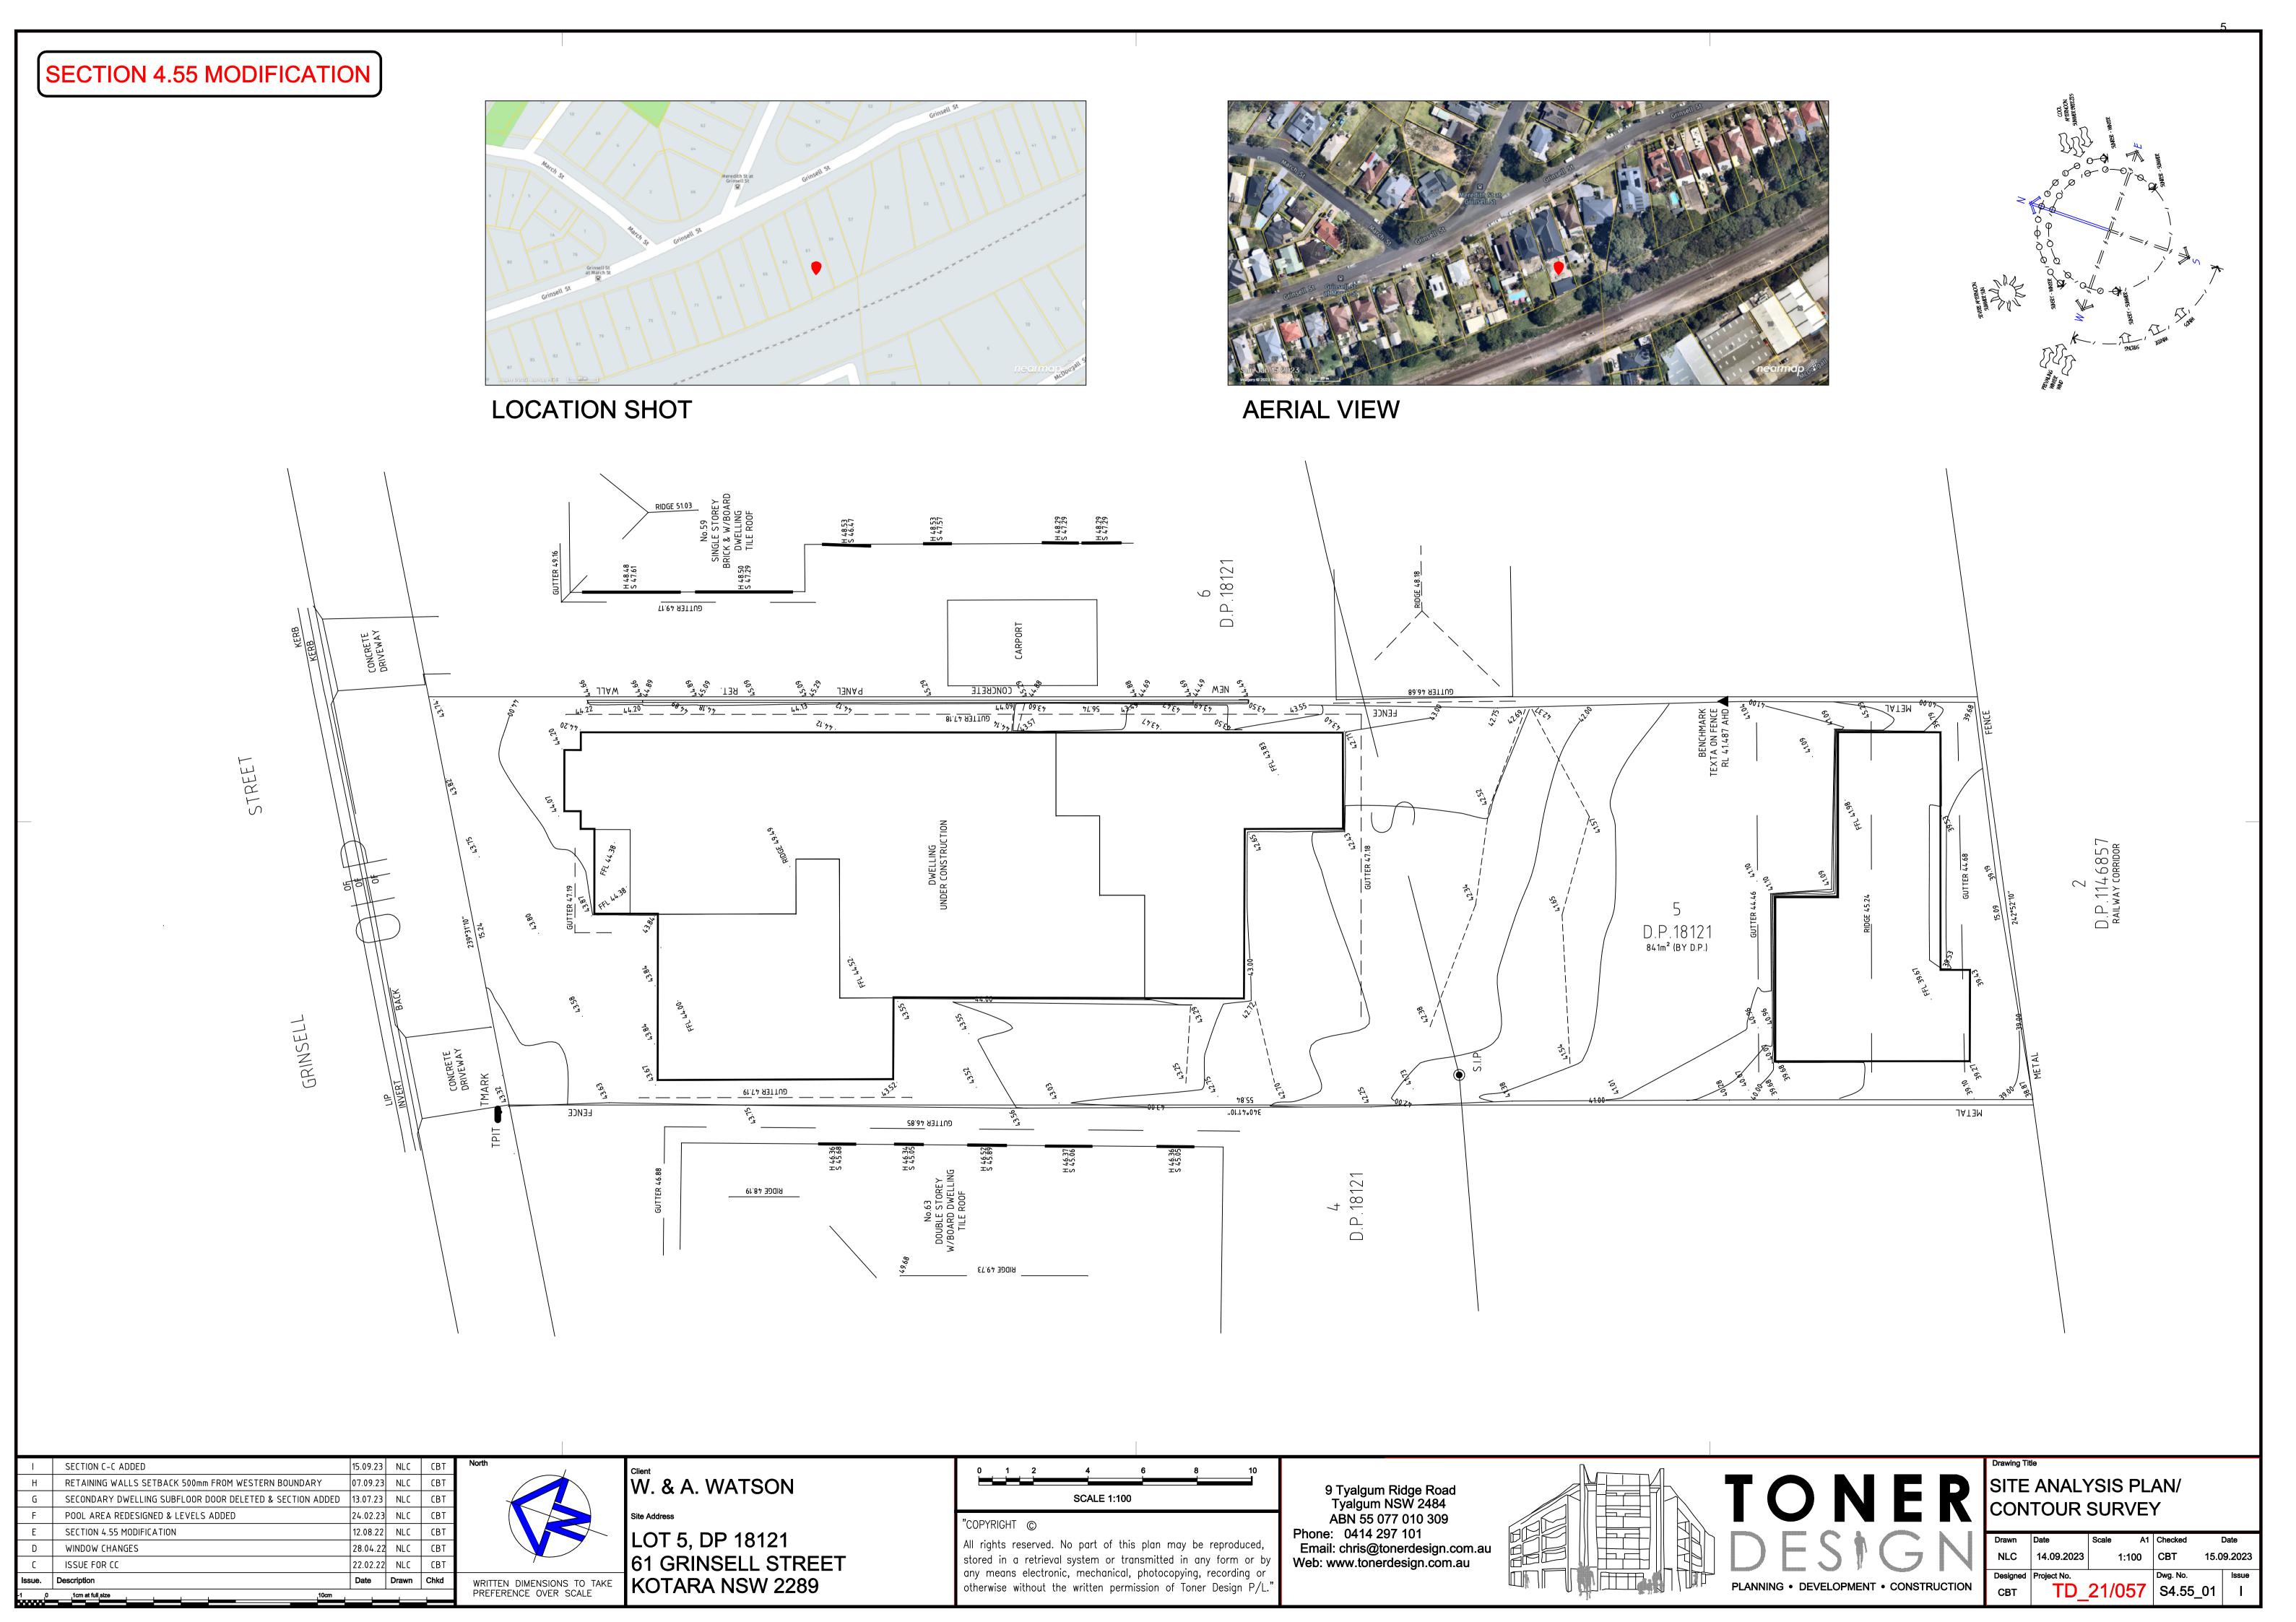GENERAL INSTRUCTIONS

- E1. THIS PLAN IS TO BE READ IN CONJUNCTION WITH THE ENGINEERING PLANS, AND ANY OTHER PLANS OR WRITTEN INSTRUCTIONS THAT MAY BE ISSUED AND RELATING TO DEVELOPMENT AT THE SUBJECT SITE.
- E2. THE SITE SUPERINTENDENT WILL ENSURE THAT ALL SOIL AND WATER MANAGEMENT WORKS ARE LOCATED AS INSTRUCTED IN THIS
- E3. ALL BUILDERS AND SUB-CONTRACTORS WILL BE INFORMED OF THEIR RESPONSIBILITIES IN MINIMISING THE POTENTIAL FOR SOIL EROSION AND POLLUTION TO DOWNSLOPE LANDS AND WATERWAYS.

CONSTRUCTION SEQUENCE

- E4. THE SOIL EROSION POTENTIAL ON THIS SITE SHALL BE MINIMISED. HENCE WORKS SHALL BE UNDERTAKEN IN THE FOLLOWING SEQUENCE: (a) INSTALL SEDIMENT FENCES
 - (b) UNDERTAKE SITE DEVELOPMENT WORKS IN ACCORDANCE WITH THE ENGINEERING PLANS. PHASE DEVELOPMENT SO THAT LAND DISTURBANCE IS CONFINED TO AREAS OF WORKABLE SIZE.

EROSION CONTROL

- E5. DURING WINDY CONDITIONS, LARGE, UNPROTECTED AREAS WILL BE KEPT MOIST (NOT WET) BY SPRINKLING WITH WATER TO KEEP DUST UNDER
- E.6. FINAL SITE LANDSCAPING WILL BE UNDERTAKEN AS SOON AS POSSIBLE AND WITHIN 20 WORKING DAYS FROM COMPLETION OF CONSTRUCTION

FENCING

- E.7. STOCKPILES WILL NOT BE LOCATED WITHIN 2 METRES OF HAZARD AREAS. INCLUDING LIKELY AREAS OF CONCENTRATED OR HIGH VELOCITY FLOWS SUCH AS WATERWAYS. WHERE THEY ARE BETWEEN 2 AND 5 METRES FROM SUCH AREAS, SPECIAL SEDIMENT CONTROL MEASURES SHOULD BE TAKEN TO MINIMISE POSSIBLE POLLUTION TO DOWNSLOPE WATERS, E.G. THROUGH INSTALLATION OF SEDIMENT FENCING.
- E.8. ANY SAND USED IN THE CONCRETE CURING PROCESS (SPREAD OVER THE SURFACE) WILL BE REMOVED AS SOON AS POSSIBLE AND WITHIN 10 WORKING DAYS FROM PLACEMENT.
- E.9. WATER WILL BE PREVENTED FROM ENTERING THE PERMANENT DRAINAGE SYSTEM UNLESS IT IS RELATIVELY SEDIMENT FREE, I.E. THE CATCHMENT AREA HAS BEEN PERMANENTLY LANDSCAPED AND/OR ANY LIKELY SEDIMENT HAS BEEN FILTERED THROUGH AN APPROVED STRUCTURE.
- E.10. TEMPORARY SOIL AND WATER MANAGEMENT STRUCTURES WILL BE REMOVED ONLY AFTER THE LANDS THEY ARE PROTECTING ARE REHABILITATED.


OTHER MATTERS

- E.11. ACCEPTABLE RECEPTORS WILL BE PROVIDED FOR CONCRETE AND MORTAR SLURRIES, PAINTS, ACID WASHINGS, LIGHT-WEIGHT WASTE MATERIALS
- E.12. RECEPTORS FOR CONCRETE AND MORTAR SLURRIES, PAINTS, ACID WASHINGS, LIGHT-WEIGHT WASTE MATERIALS AND LITTER ARE TO BE EMPTIED AS NECESSARY. DISPOSAL OF WASTE SHALL BE IN A MANNER APPROVED BY THE SITE SUPERINTENDENT.

SITE INSPECTION & MAINTENANCE

E.13. EROSION AND SEDIMENT CONTROL MEASURES SHALL BE INSPECTED AFTER RAINFALL EVENTS TO ENSURE THAT THEY OPERATE EFFECTIVELY. REPAIR AND OR MAINTENANCE SHALL BE UNDERTAKEN AS REQUIRED.



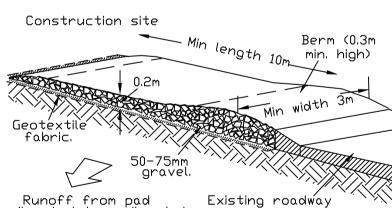


TEMPORARY CONSTRUCTION EXIT

MAINTENANCE:
THE ENTRANCE SHALL BE MAINTAINED IN A
CONDITION
WHICH PREVENTS TRACKING OR FLOWING OF SEDIMENT


ONTO PUBLIC RIGHTS OF WAY. THIS MAY REQUIRE PERIODIC TOP DRESSING WITH ADDITIONAL GRAVEL

CONDITIONS DEMAND AND REPAIR AND / OR CLEANOUT OF ANY MEASURES USED TO TRAP
SEDIMENT. ALL SEDIMENT SPILLED, DROPPED,
WASHED
OR TRACKED ONTO PUBLIC RIGHTS OF WAY MUST BE REMO∨ED IMMEDIATELY

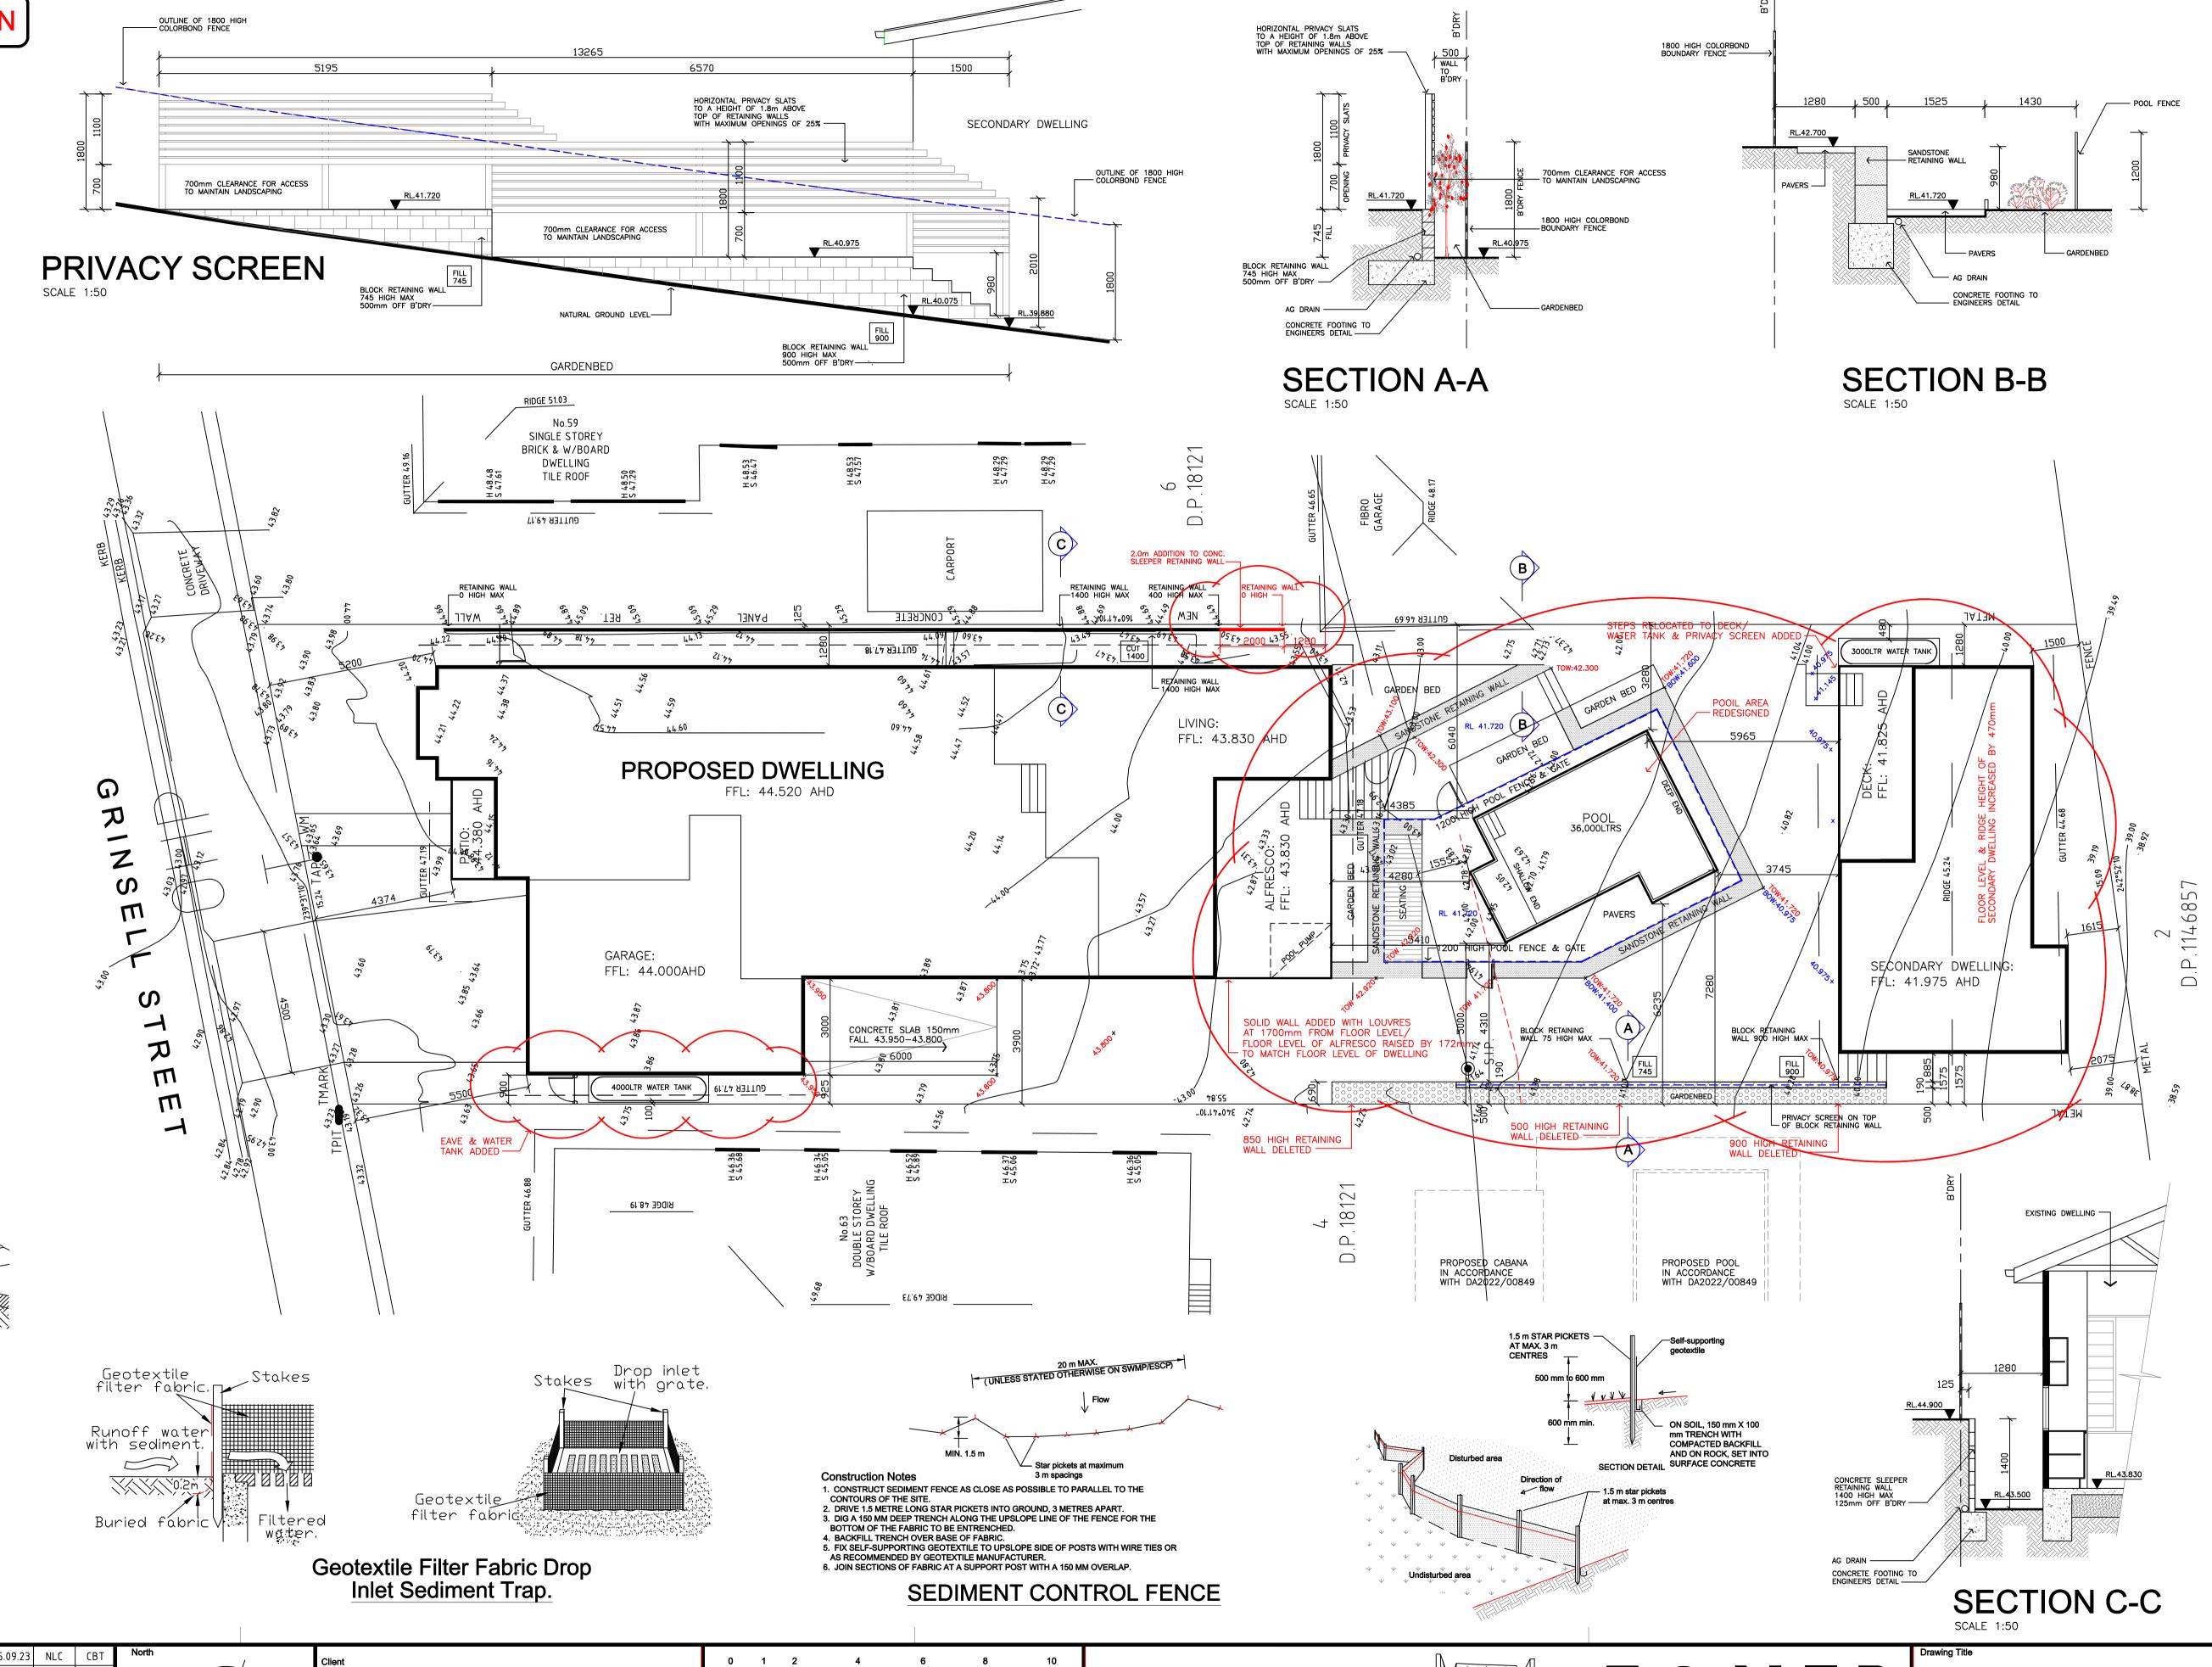


SECTION C-C ADDED 07.09.23 NLC RETAINING WALLS SETBACK 500mm FROM WESTERN BOUNDARY SECONDARY DWELLING SUBFLOOR DOOR DELETED & SECTION ADDED | 13.07.23 | NLC | 24.02.23 NLC CBT POOL AREA REDESIGNED & LEVELS ADDED 12.08.22 NLC CBT SECTION 4.55 MODIFICATION WINDOW CHANGES 28.04.22 NLC | CBT 22.02.22 NLC CBT ISSUE FOR CO Description Drawn Chkd

.1cm at full,size

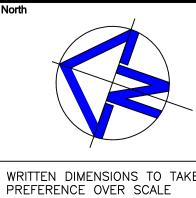

W. & A. WATSON

LOT 5, DP 18121 61 GRINSELL STREET KOTARA NSW 2289

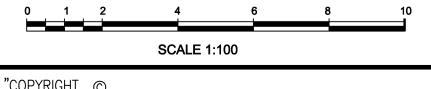


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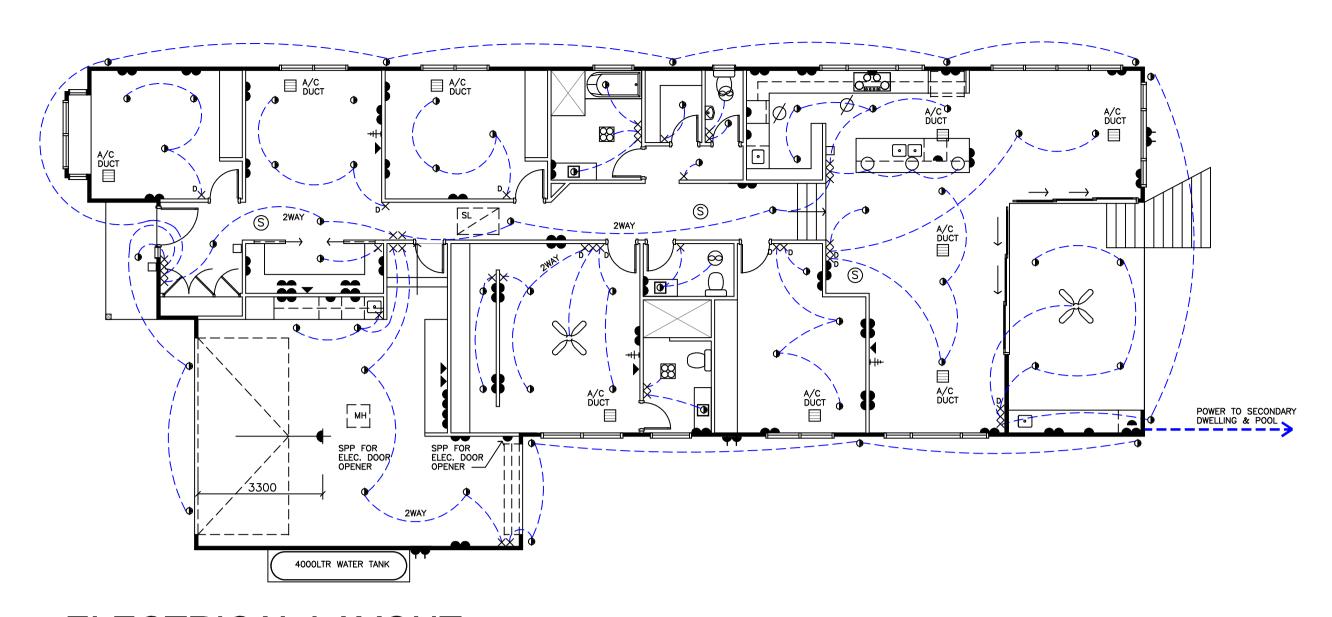
9 Tyalgum Ridge Road Tyalgum NSW 2484 ABN 55 077 010 309 Phone: 0414 297 101 Email: chris@tonerdesign.com.au Web: www.tonerdesign.com.au



14.09.2023 | 1:100/1:50 15.09.2023 TD_21/057 | S4.55_02 CBT

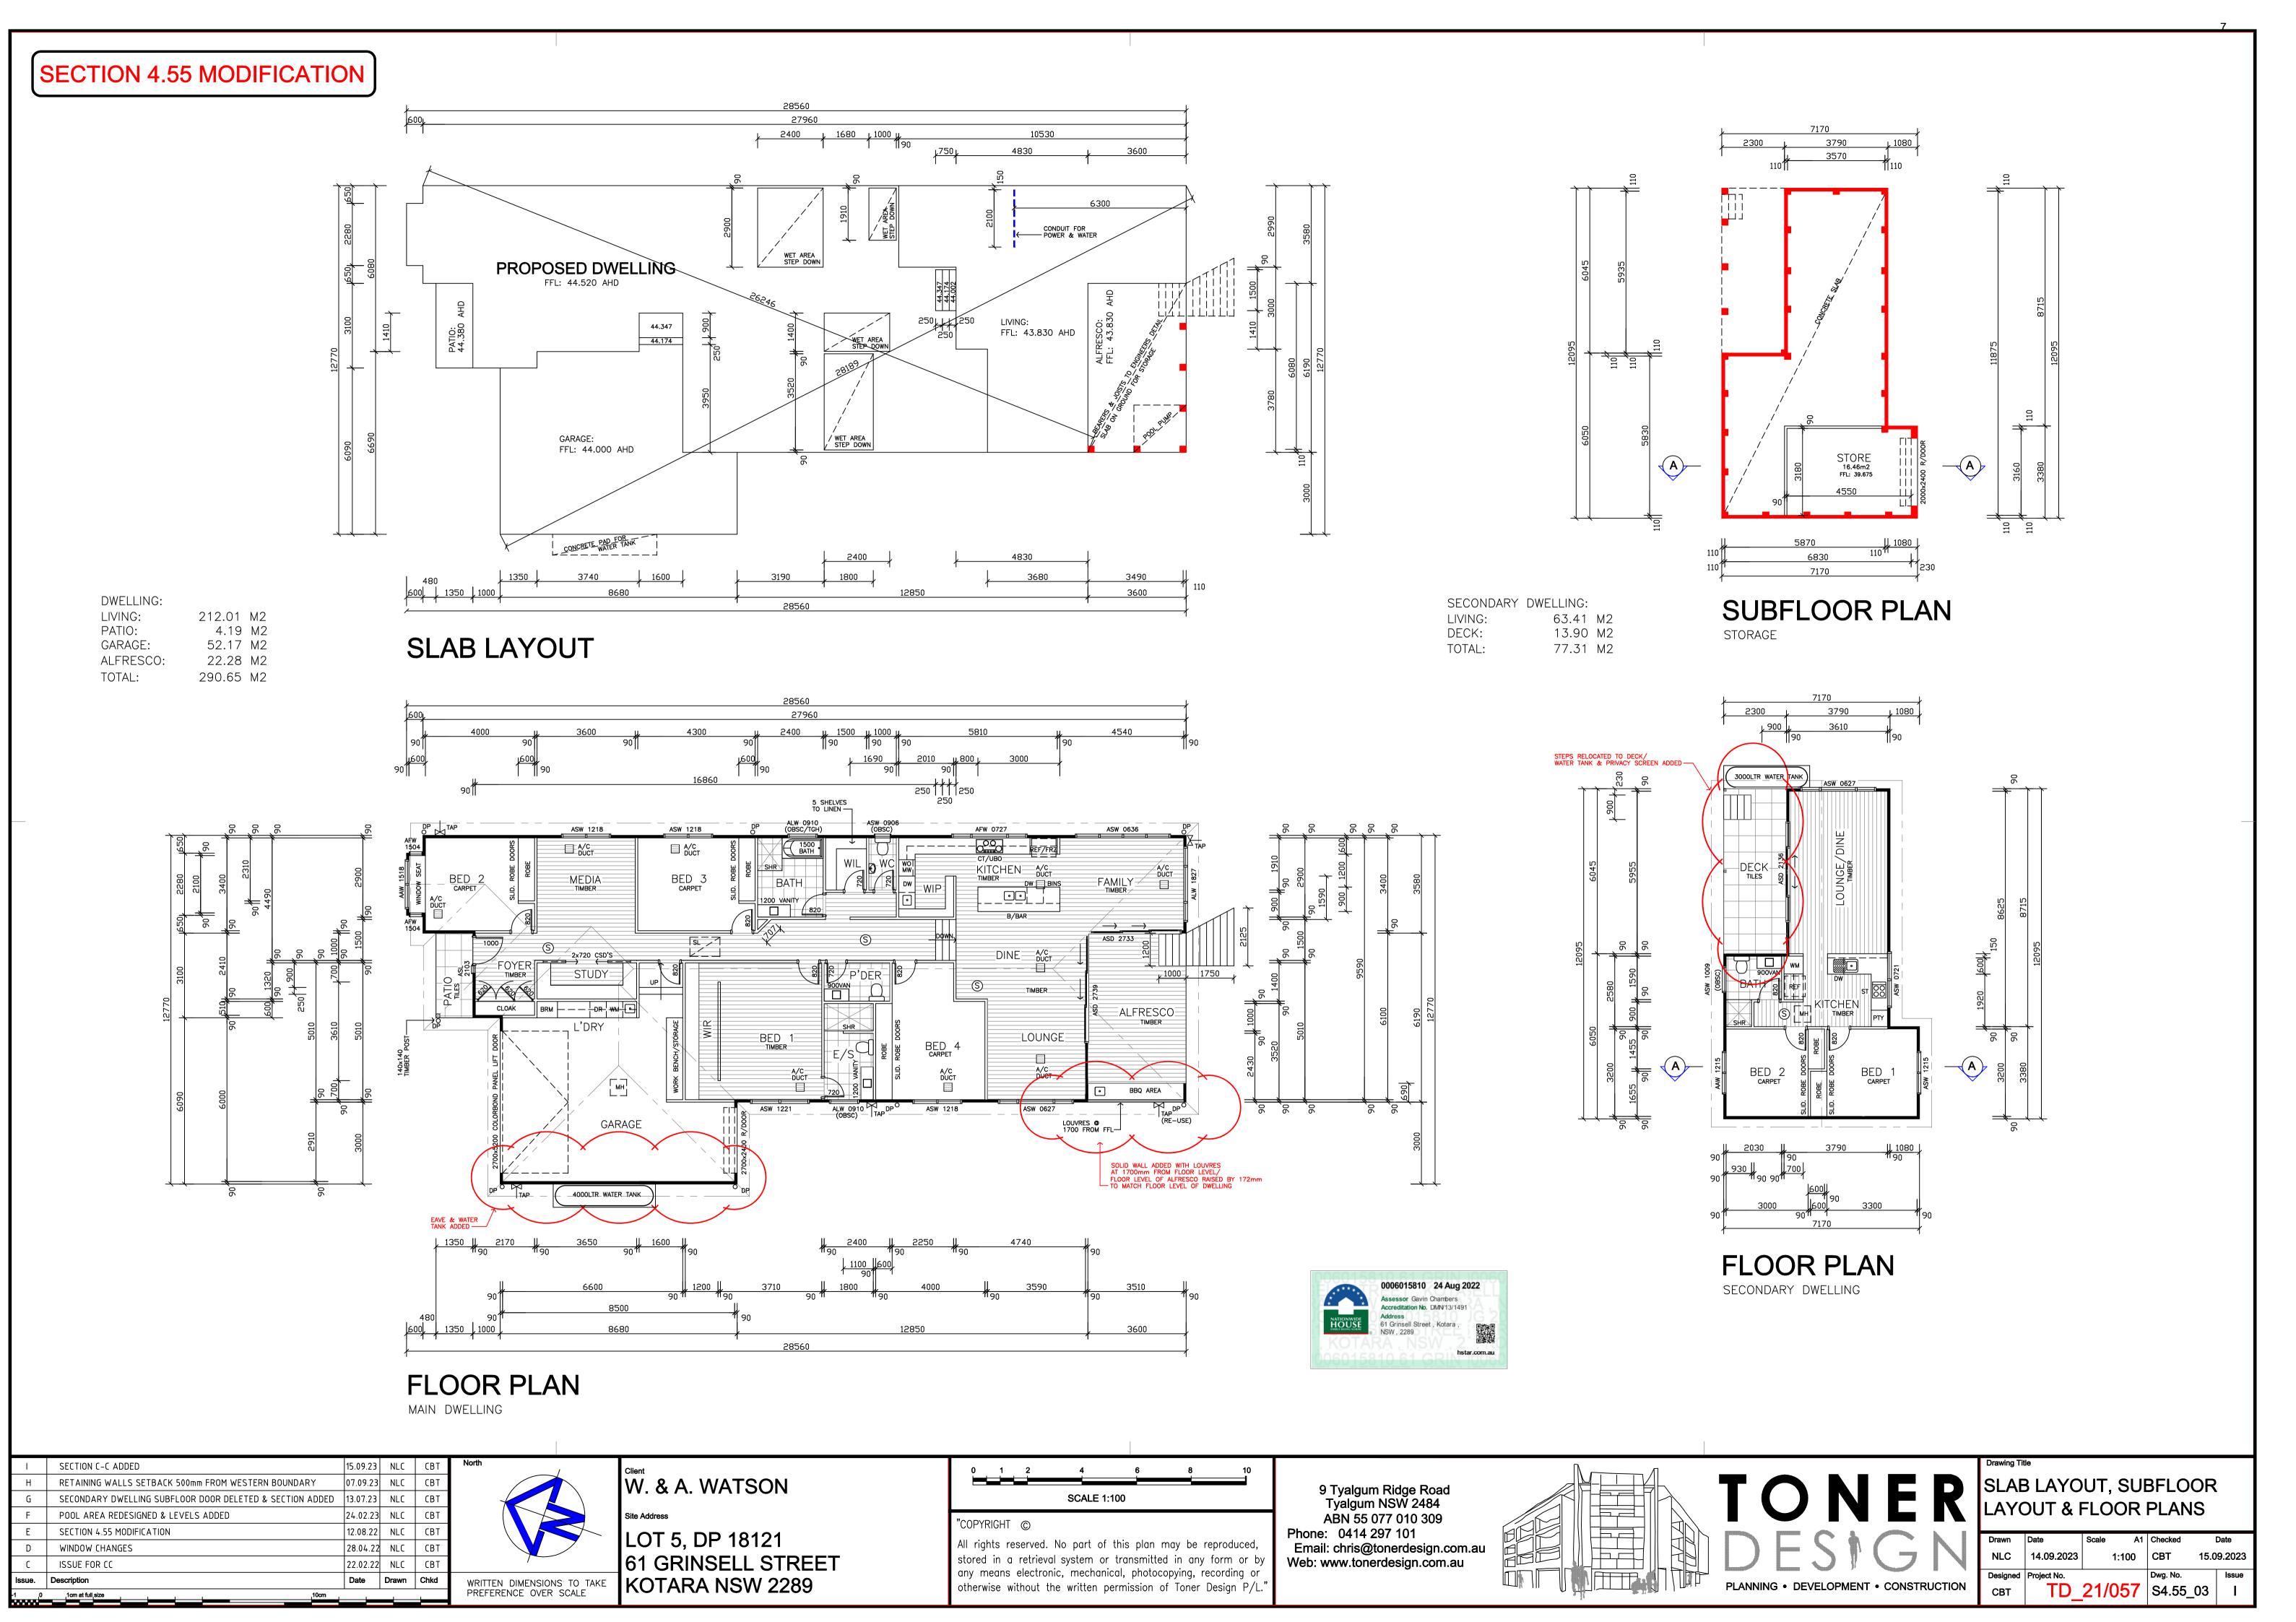

SECTION 4.55 MODIFICATION




ELECTRICAL LEGEND BATTEN HOLDER - CEILING OH BATTEN HOLDER - WALL X SWITCH POSITION XD DIMMER SWITCH POSITION PERMANENT POWER SINGLE POWER POINT DOUBLE POWER POINT ▲▲ WEATHER PROOF P/ POINT S SMOKE ALARM ◆ LED DOWN LIGHT


⊢∰ GAS POINT

∠ LED FLURO

☐ INTERCOM POINT DATA POINT

FAN/LIGHT/HEATER (2 OR 4)

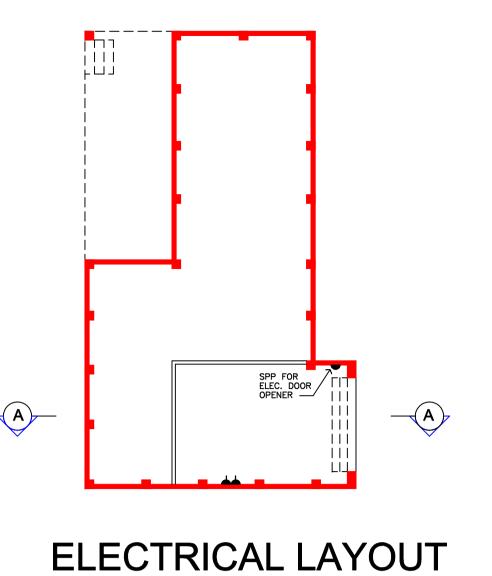

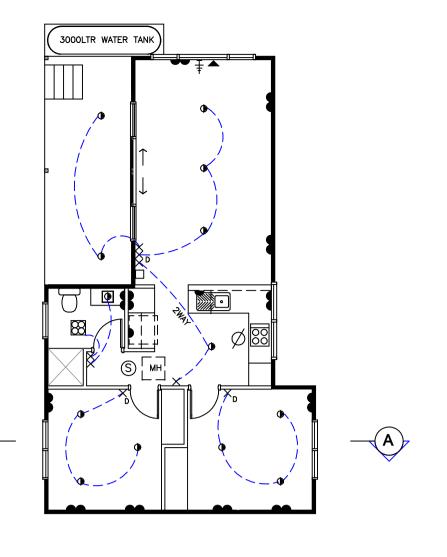



ELECTRICAL LAYOUT

SECONDARY DWELLING

ELECTRICAL LAYOUT

MAIN DWELLING

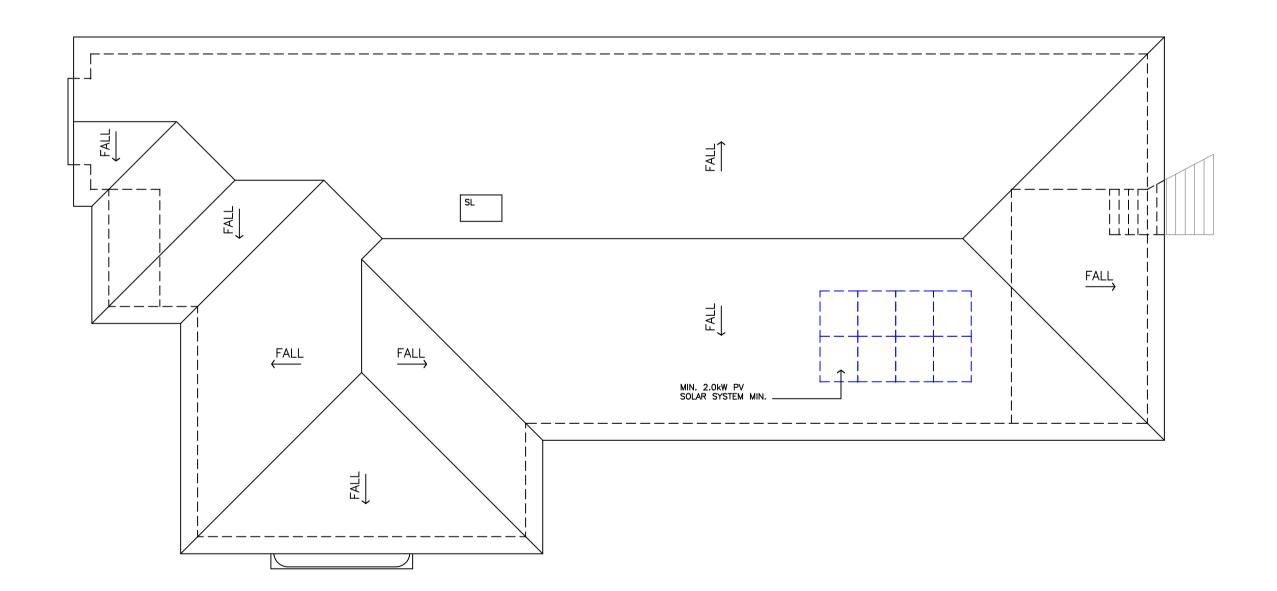

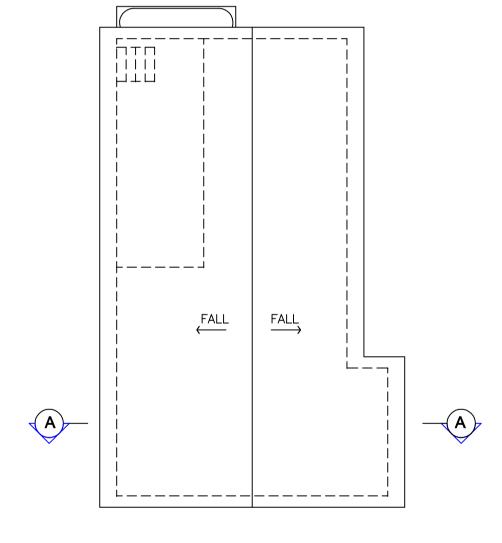



Thermal Performance Specifications (does not apply to garage) External Wall Construction Adde

Windows	Glass and frame type	U Value	SHGC Range	Area
ALM-001-03 A	Al. A SG High Solar Gain Low-E	5.40	0.44 - 0.54	As c
ALM-002-03 A	Al. B SG High Solar Gain Low-E	5.40	0.52 - 0.64	As d
Time A subadassa	an accuring colorion bifolds assessed	All In Normal		
Type A Windows 8	are awning windows, bifolds, casements,	un n tum	winaows, entry aoor	s, mencn ad
<u>,, </u>	are awning windows, birolas, casements, are double hung windows, sliding window		<u> </u>	

ROOF LAYOUT

SECONDARY DWELLING

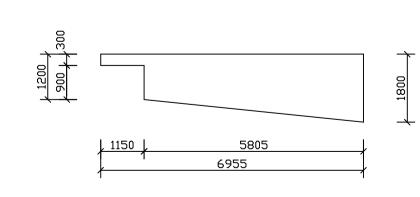

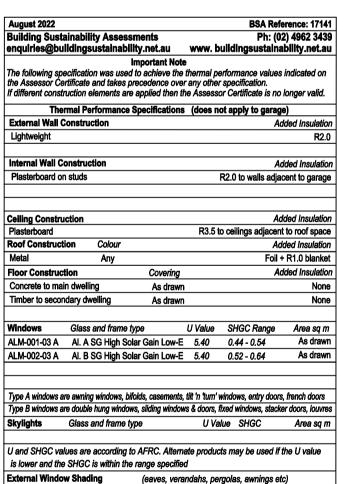


WATER COI									
3 Star Showe	r Heads		Yes						
3 Star Kitche	n / Basin	Taps	Yes		1	Star Toi	let	Yes	
Alternative W	/ater							_	
Minimum Tan	k Size (L)) 2	2000	Collected	d fr	om Roof	Are	a (m2)	60
Tank Connec	ted To:							•	
All Toilets	Yes		Laund	ry \	W/M Cold	Тар	Yes		
One Outdoor	Yes								
THERMAL CO	OMFORT	COMM	ITMEN	TS - Refe	r tc	TPA Sp	ecifi	cation o	n plans
ENERGY CO	MMITMEN	ITS							
Hot Water	Electric I	leat Pu	mp 26 t	o 30 STCs					
Cooling	Living		Refer E	ASIX Certif	ica	te			
System Bedroo		ms	Refer B	ASIX Certif	ica	te			
Heating	Living	Refer BASIX Certificate							
System	Bedroo	Bedrooms Refer BASIX Certificate							
	1 x Bath	1 x Bathroom Fan ducted to exterior				Manual o	on/off		
Ventilation	Kitchen	Kitchen Fan ducted to exterior			•	Manual on/off			
	Laundry	,	As drawn						
Natural	Window	<u> </u>						Yes	
Lighting				athrooms/	То	ilets		As draw	n
Artificial	Number					All		dicated	No
Lighting			ng/Dini	ng rooms		All		dicated	No
(rooms to be orimarily lit by	Kitchen					Yes		dicated	No
fluorescent or	All Bath		ilets			Yes		dicated	No
LED lights)	Laundr					Yes		dicated	No
• ,	All Hall					Yes	De	dicated	No
OTHER COM									
Outdoor cloth	es line		'es			refrigerat	or sp	oace	Yes
Stove/Oven				ooktop & el	ect	ric oven			
Alternative Er			<u> </u>	em: 2kw					
Pool Max vo	ol: 48KL, no	heating	, pump	with timer,	pod	ol cover			


61 Grinsell Street Kotara

SUMMARY OF BASIX COMMITMENTS FOR EACH UNIT


This is a summary of the BASIX Commitments as detailed in the BASIX Certificate. Refer to the CURRENT BASIX Certificate for Complete details. For definitions refer to basix.nsw.gov.au

ROOF LAYOUT MAIN DWELLING

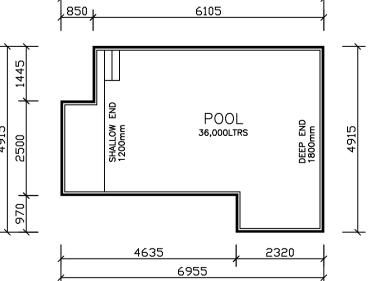

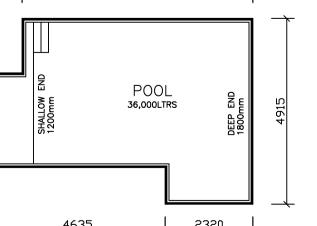


sue.	Description	Date	Drawn	Chkd
С	ISSUE FOR CC	22.02.22	NLC	СВТ
D	WINDOW CHANGES	28.04.22	NLC	СВТ
Е	SECTION 4.55 MODIFICATION	12.08.22	NLC	СВТ
F	POOL AREA REDESIGNED & LEVELS ADDED	24.02.23	NLC	СВТ
G	SECONDARY DWELLING SUBFLOOR DOOR DELETED & SECTION ADDED	13.07.23	NLC	СВТ
Н	RETAINING WALLS SETBACK 500mm FROM WESTERN BOUNDARY	07.09.23	NLC	СВТ
1	SECTION C-C ADDED	15.09.23	NLC	СВТ

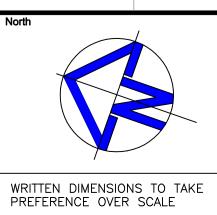

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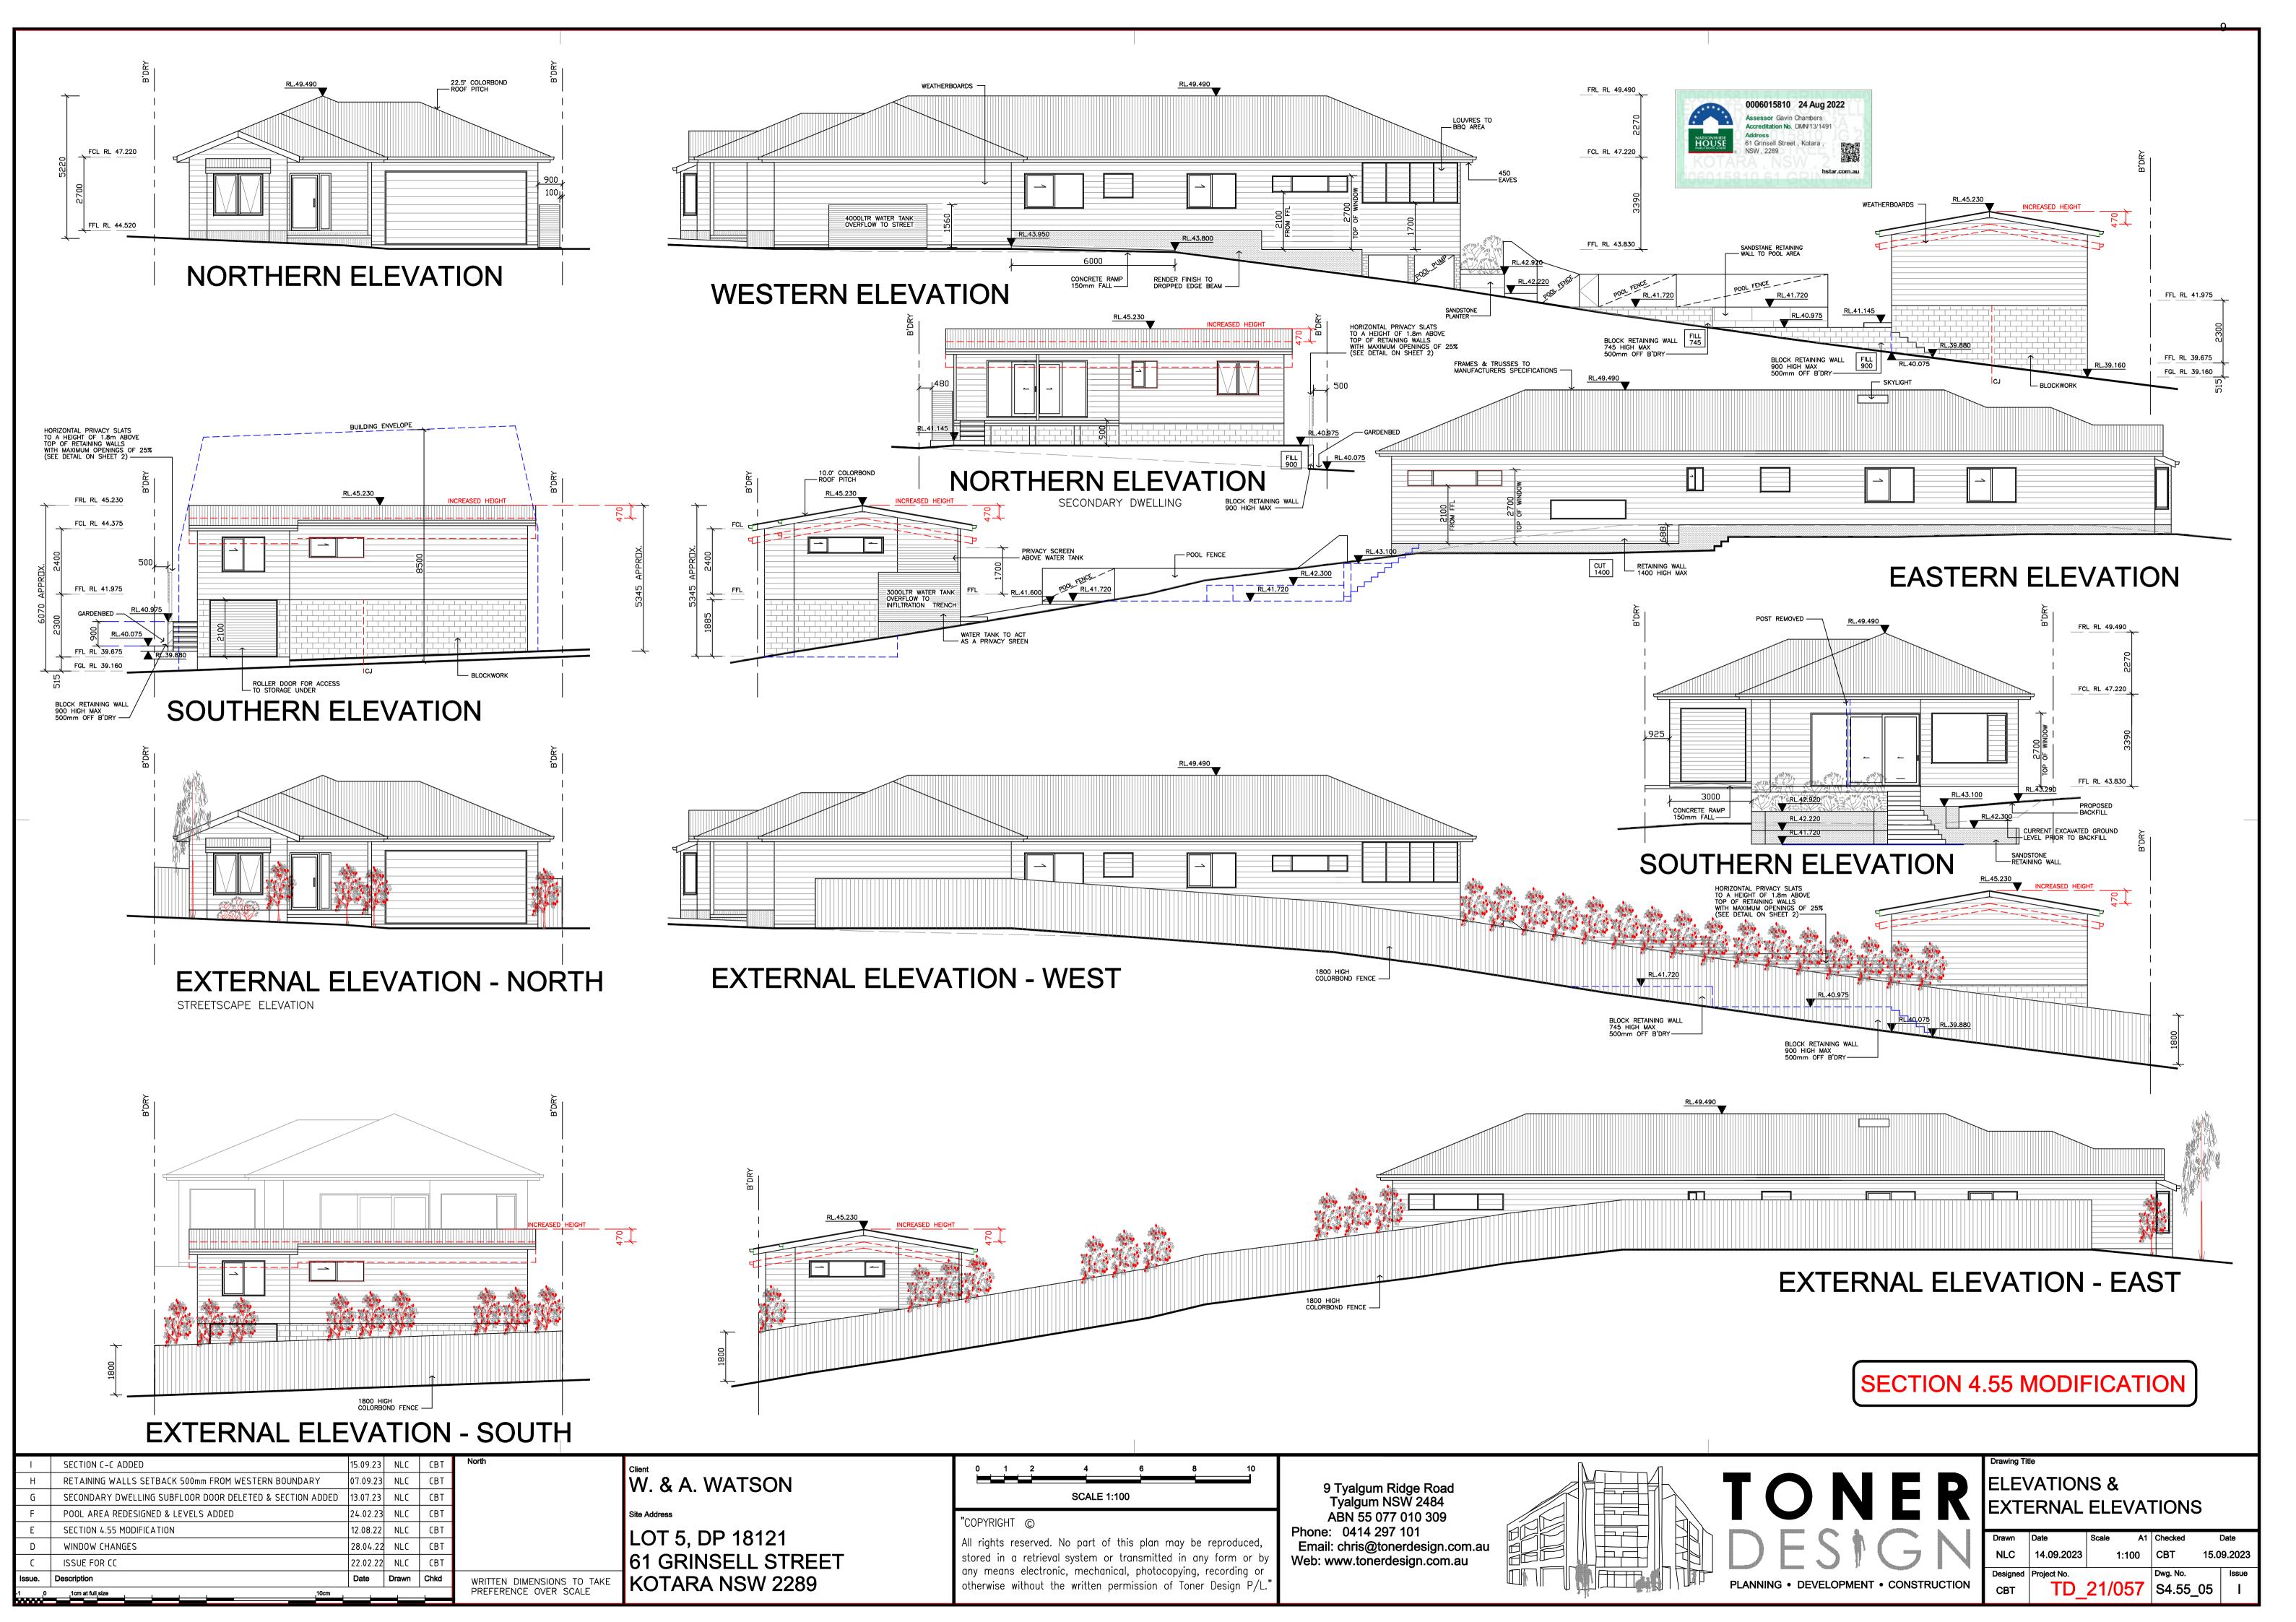
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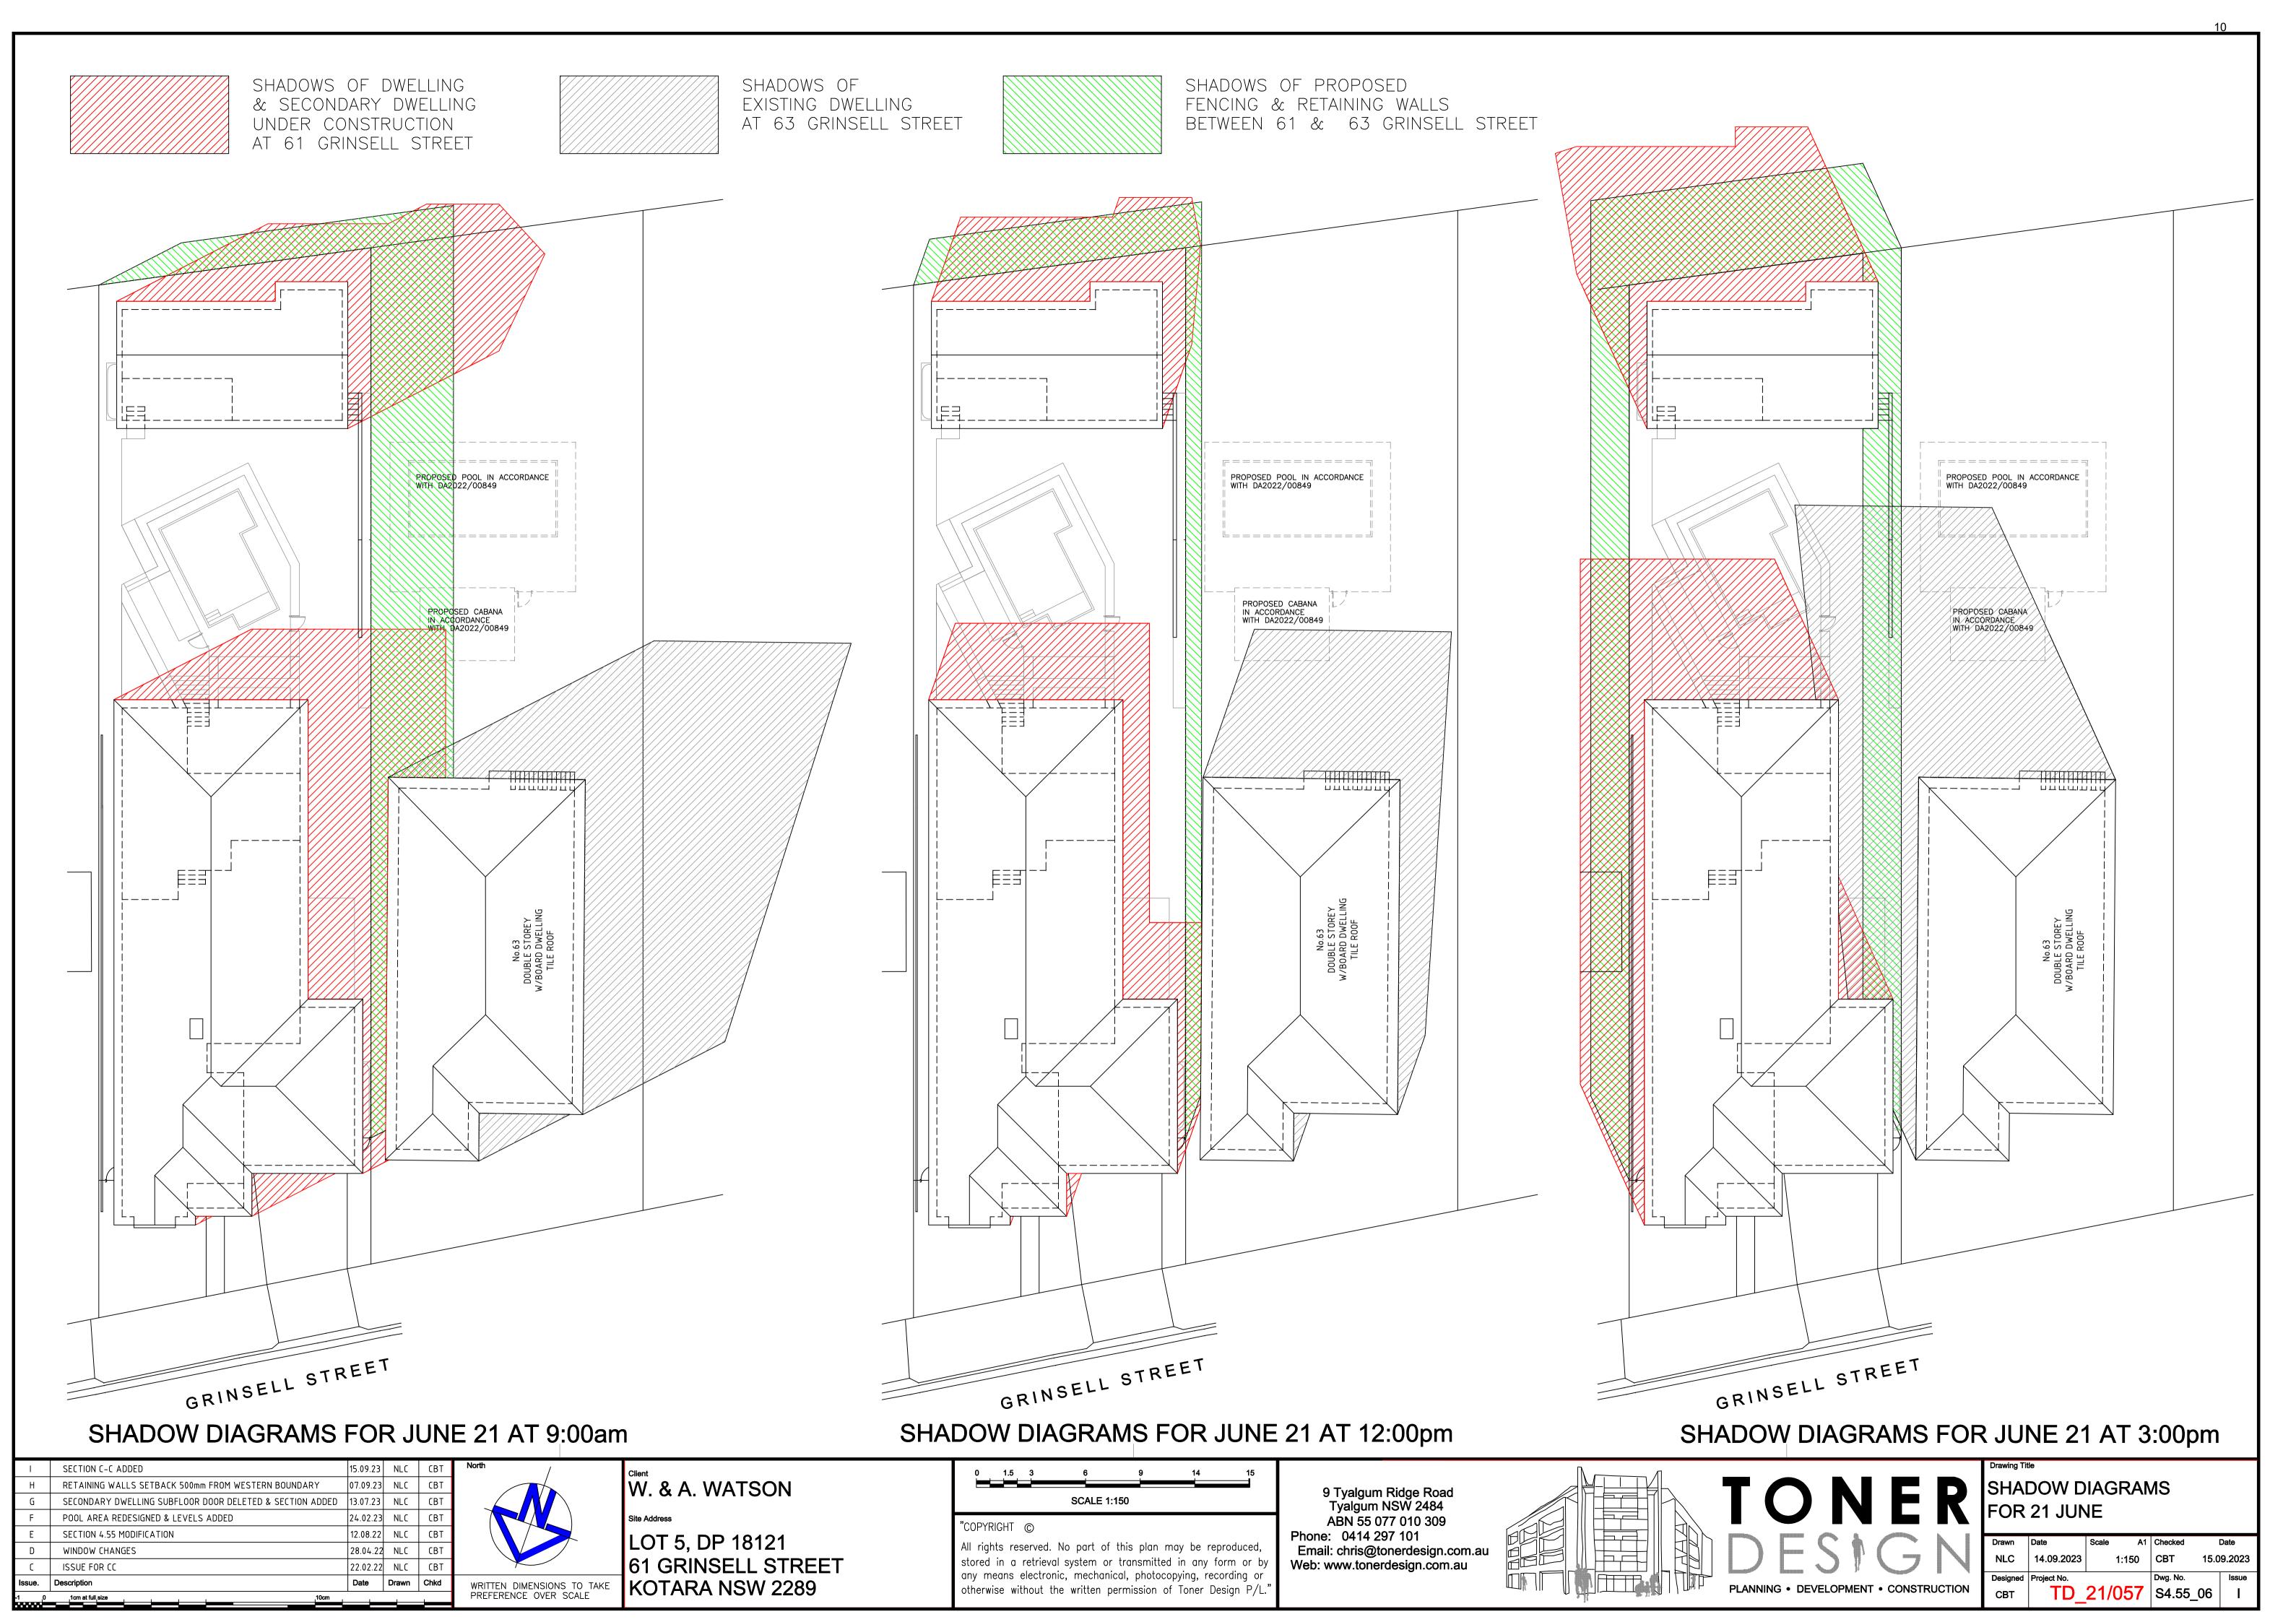
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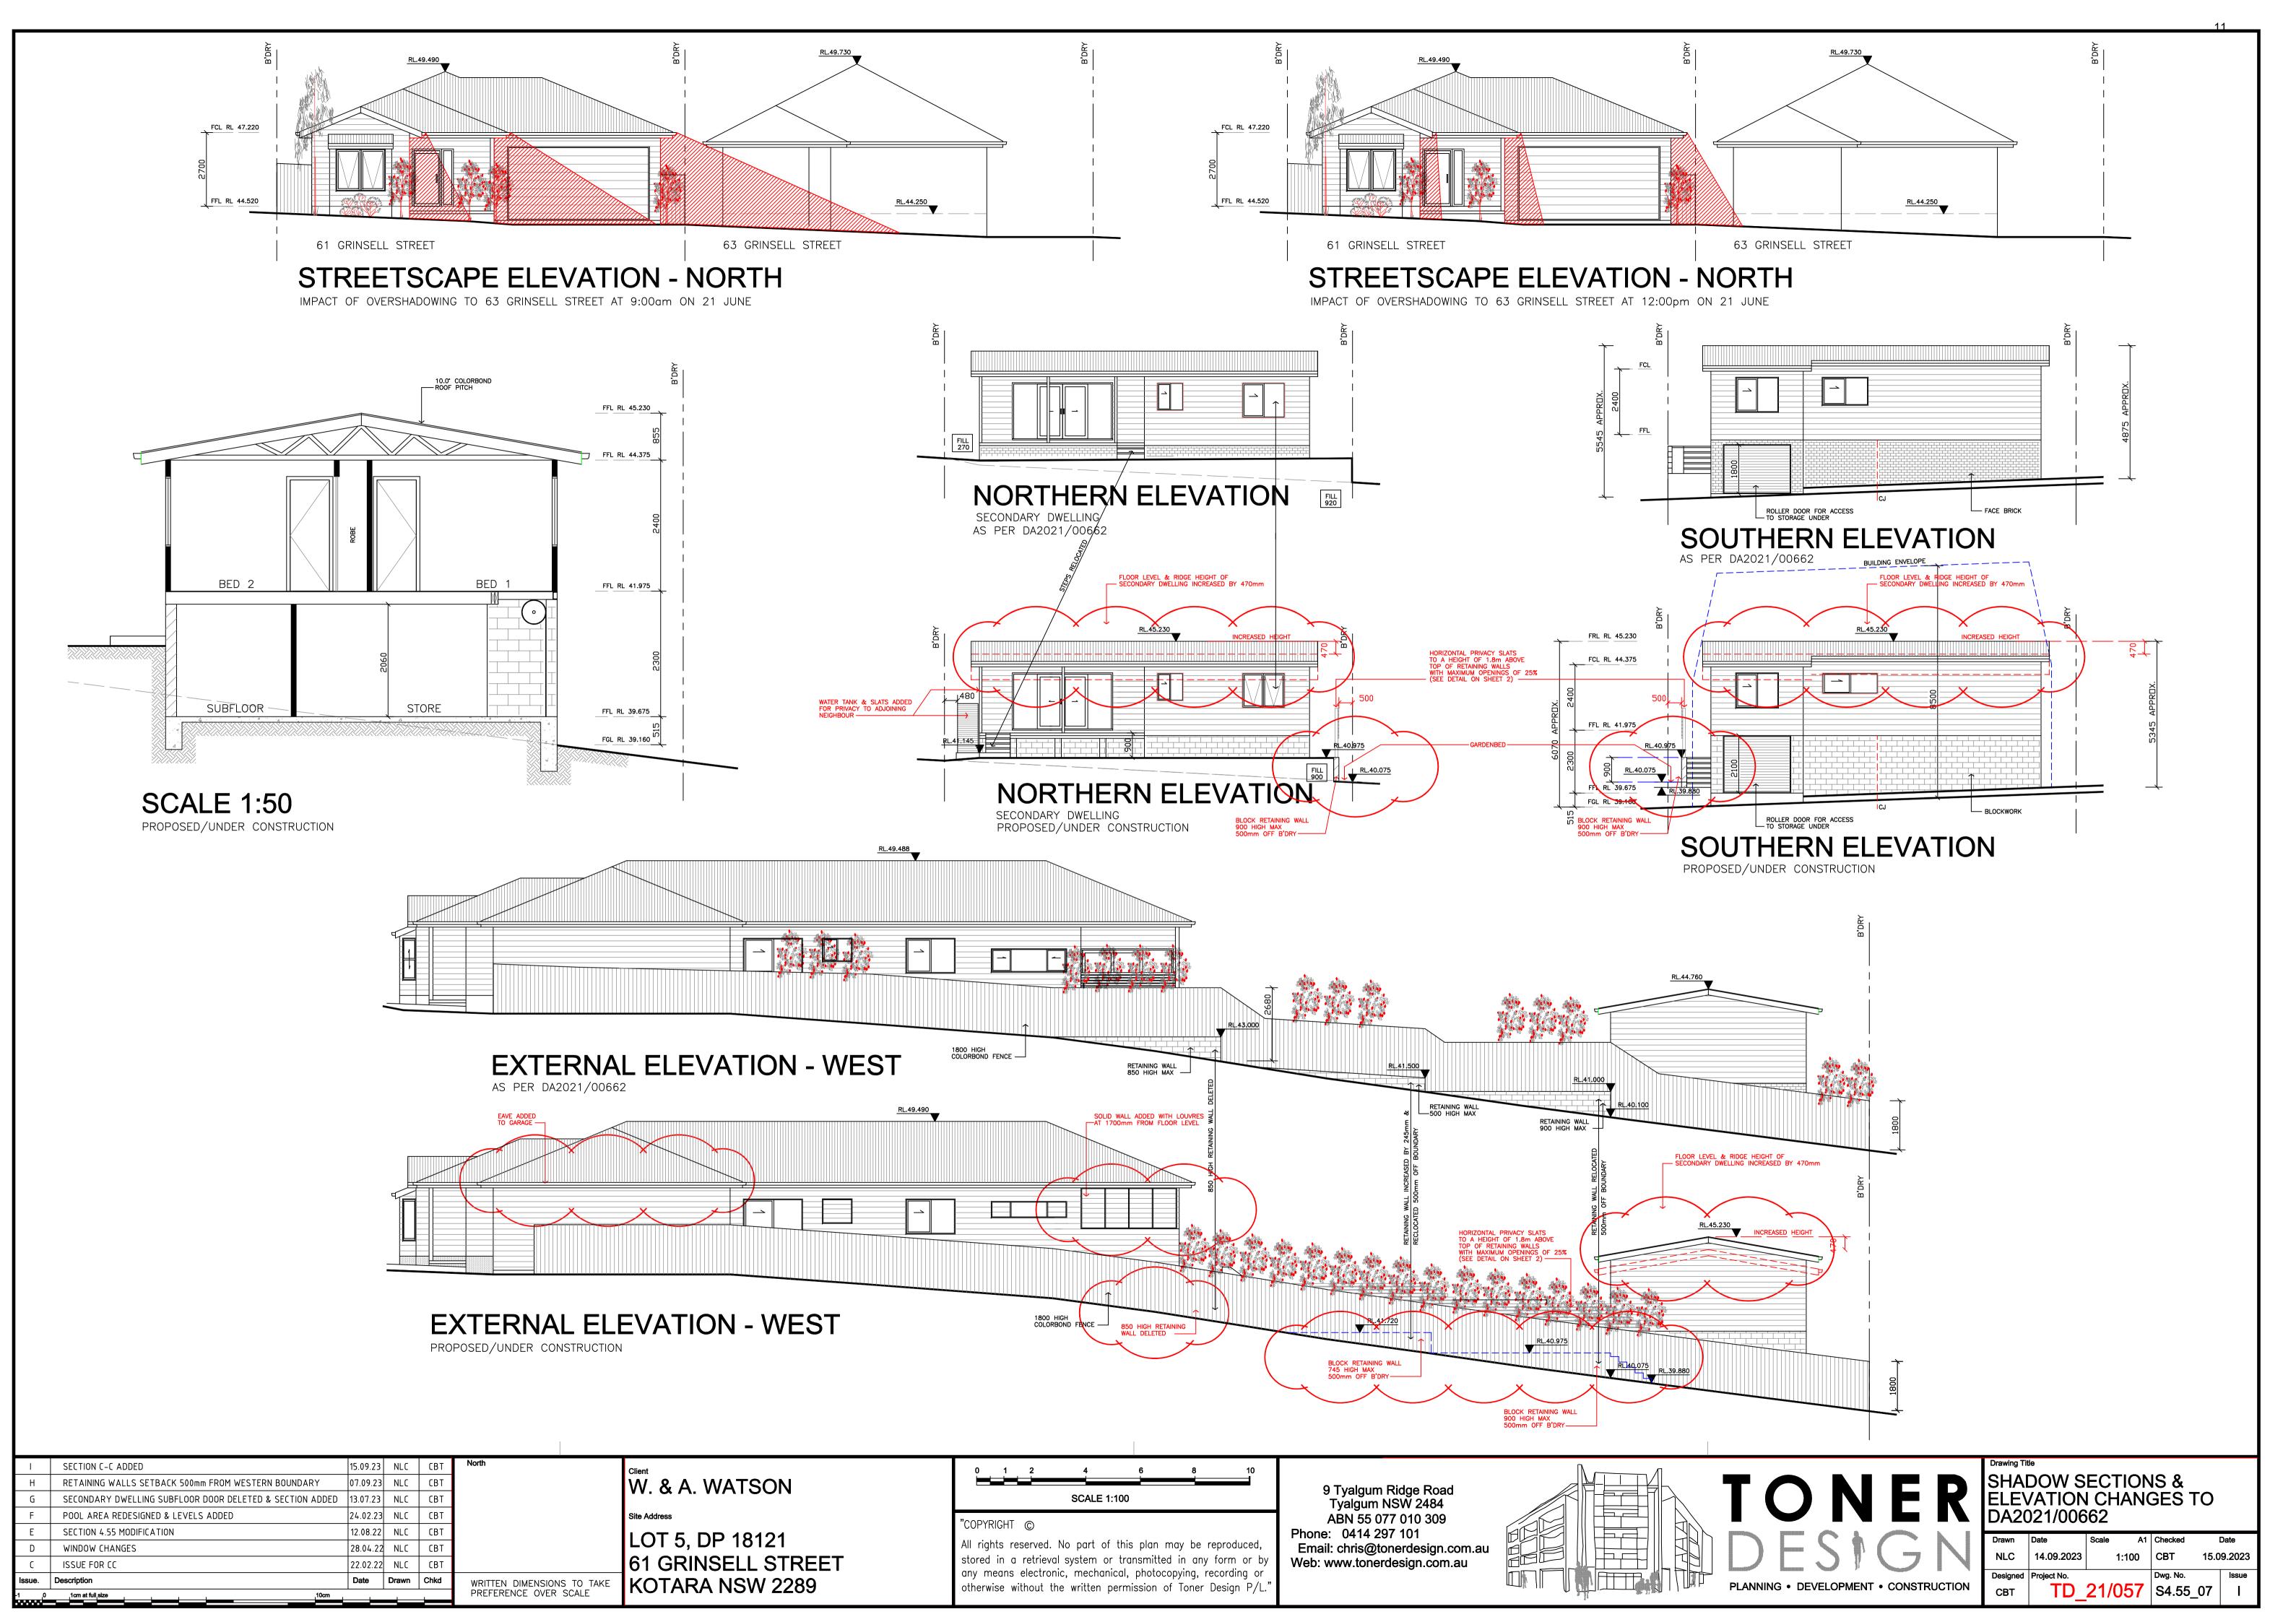



Drawing Title
ELECTRICAL LAYOUTS &
BASIX REQUIREMENTS

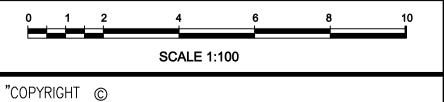Drawn	Date	Scale	A1	Checked	ı	Date
NLC	14.09.2023		1:100	СВТ	15.0	9.2023
Designed	Project No.	ı		Dwg. No.		Issue
CBT	TD_	21/	057	S4.55_	_04	I







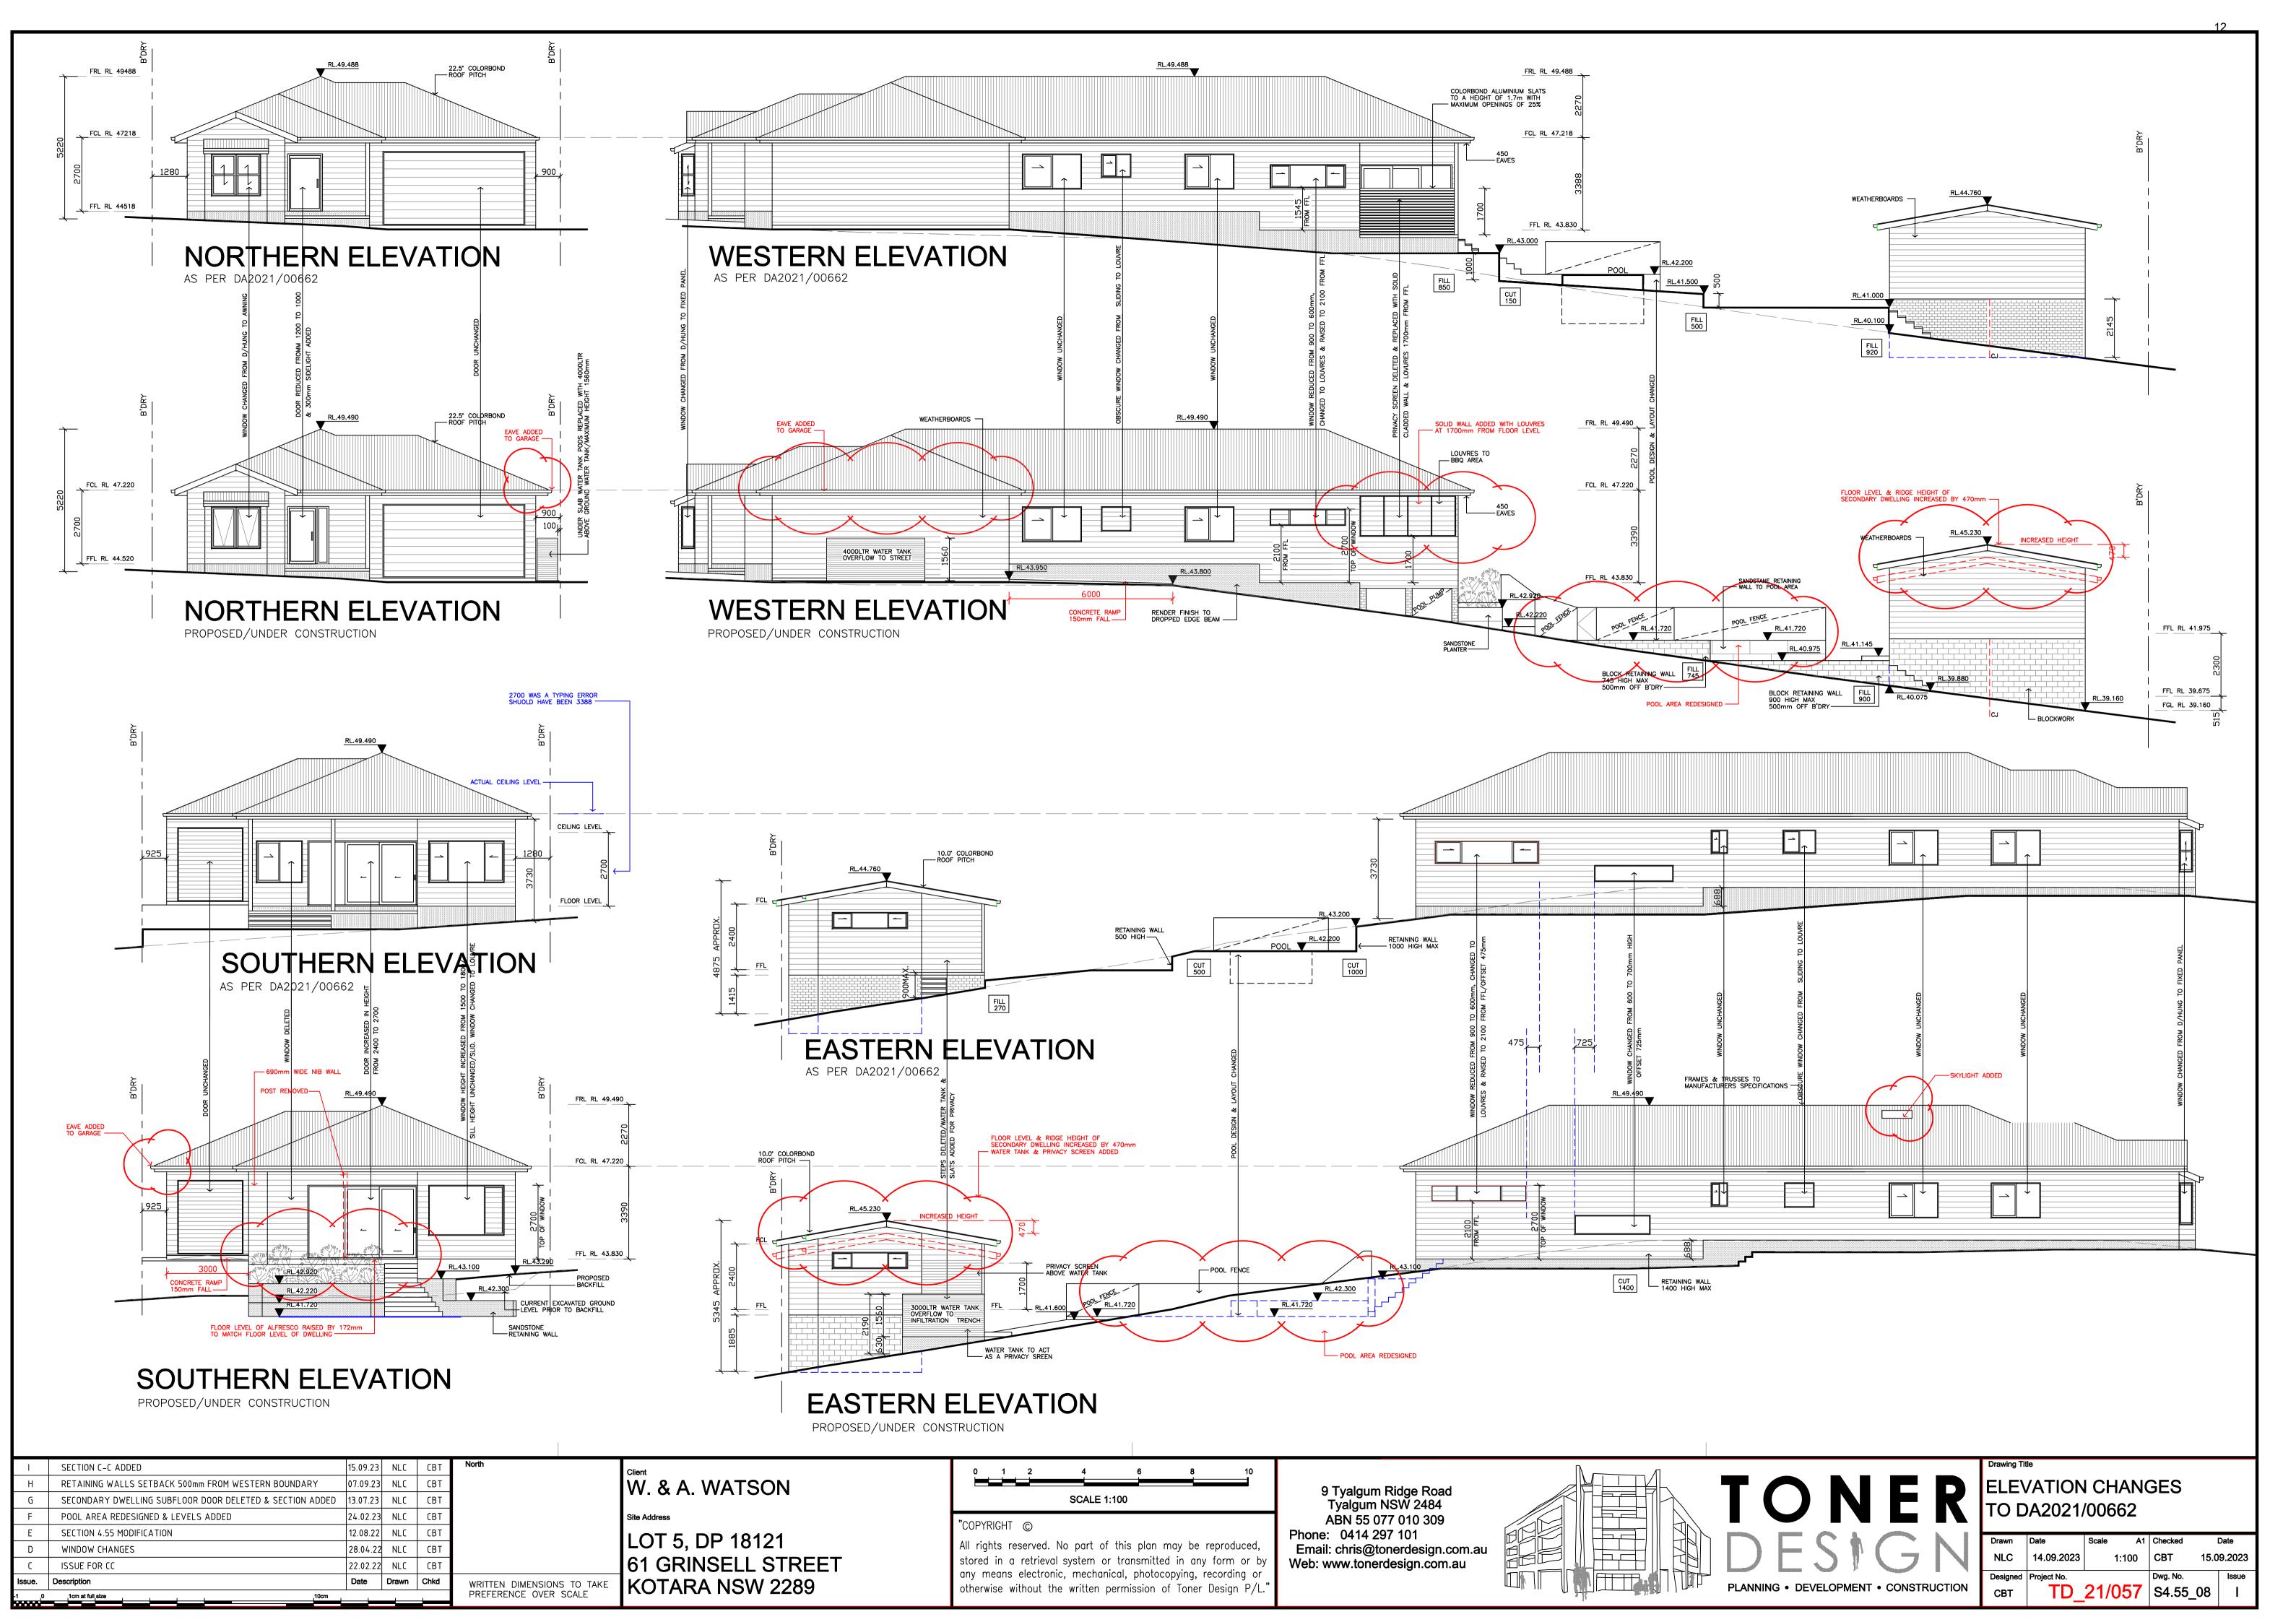

AS ACCESS TO 63 GRINSELL WAS DENIED TO CONDUCT A VIEW ANALYSIS, WE ASSUME THE VIEW OF THIS PHOTO AS VIEWED FORM BEDROOM 4 AND RUMPUS OF 63 GRINSELL BASED ON THE FOLLWING CALCULATIONS: TOP OF WINDOW HEIGHTS TO 63 GRINSELL STREET: RL46.350 FINISHED FLOOR LEVEL OF 63 GRINSELL STREET: 46.350 - 2.100 = RL44.250 FINISHED FLOOR LEVEL TO REAR LIVING AREA OF 61 GRINSELL STREET: RL43.830 (WHERE PHOTO TAKEN) DIFFERENCE OF FLOOR LEVELS: 420mm/ADD 1200mm FOR EYE LEVEL OF PERSON SITTING ON A CHAIR: 1620mm CAMERA LENSE POSITIONED AT 1620mm ABOVE RL43.830



RAIL LINE BEHIND SECONDARY DWELLING TREE BEHIND REAR

APPROXIMATE VIEW OVER RIDGE LINE OF SECONDARY DWELLING FROM BEDROOM 4 AND RUMPUS OF 63 GRINSELL STREET (SEEN FROM 61 GRINSELL STREET)




REAR VIEW OF DWELLING AT 63 GRINSELL STREET



OUTLOOK FROM REAR OF 63 GRINSELL STREET PRIOR TO DEMOLITION OF SHED AND ERECTION SECONDARY DWELLING (STANDING ON CONCRETE SLAB) —





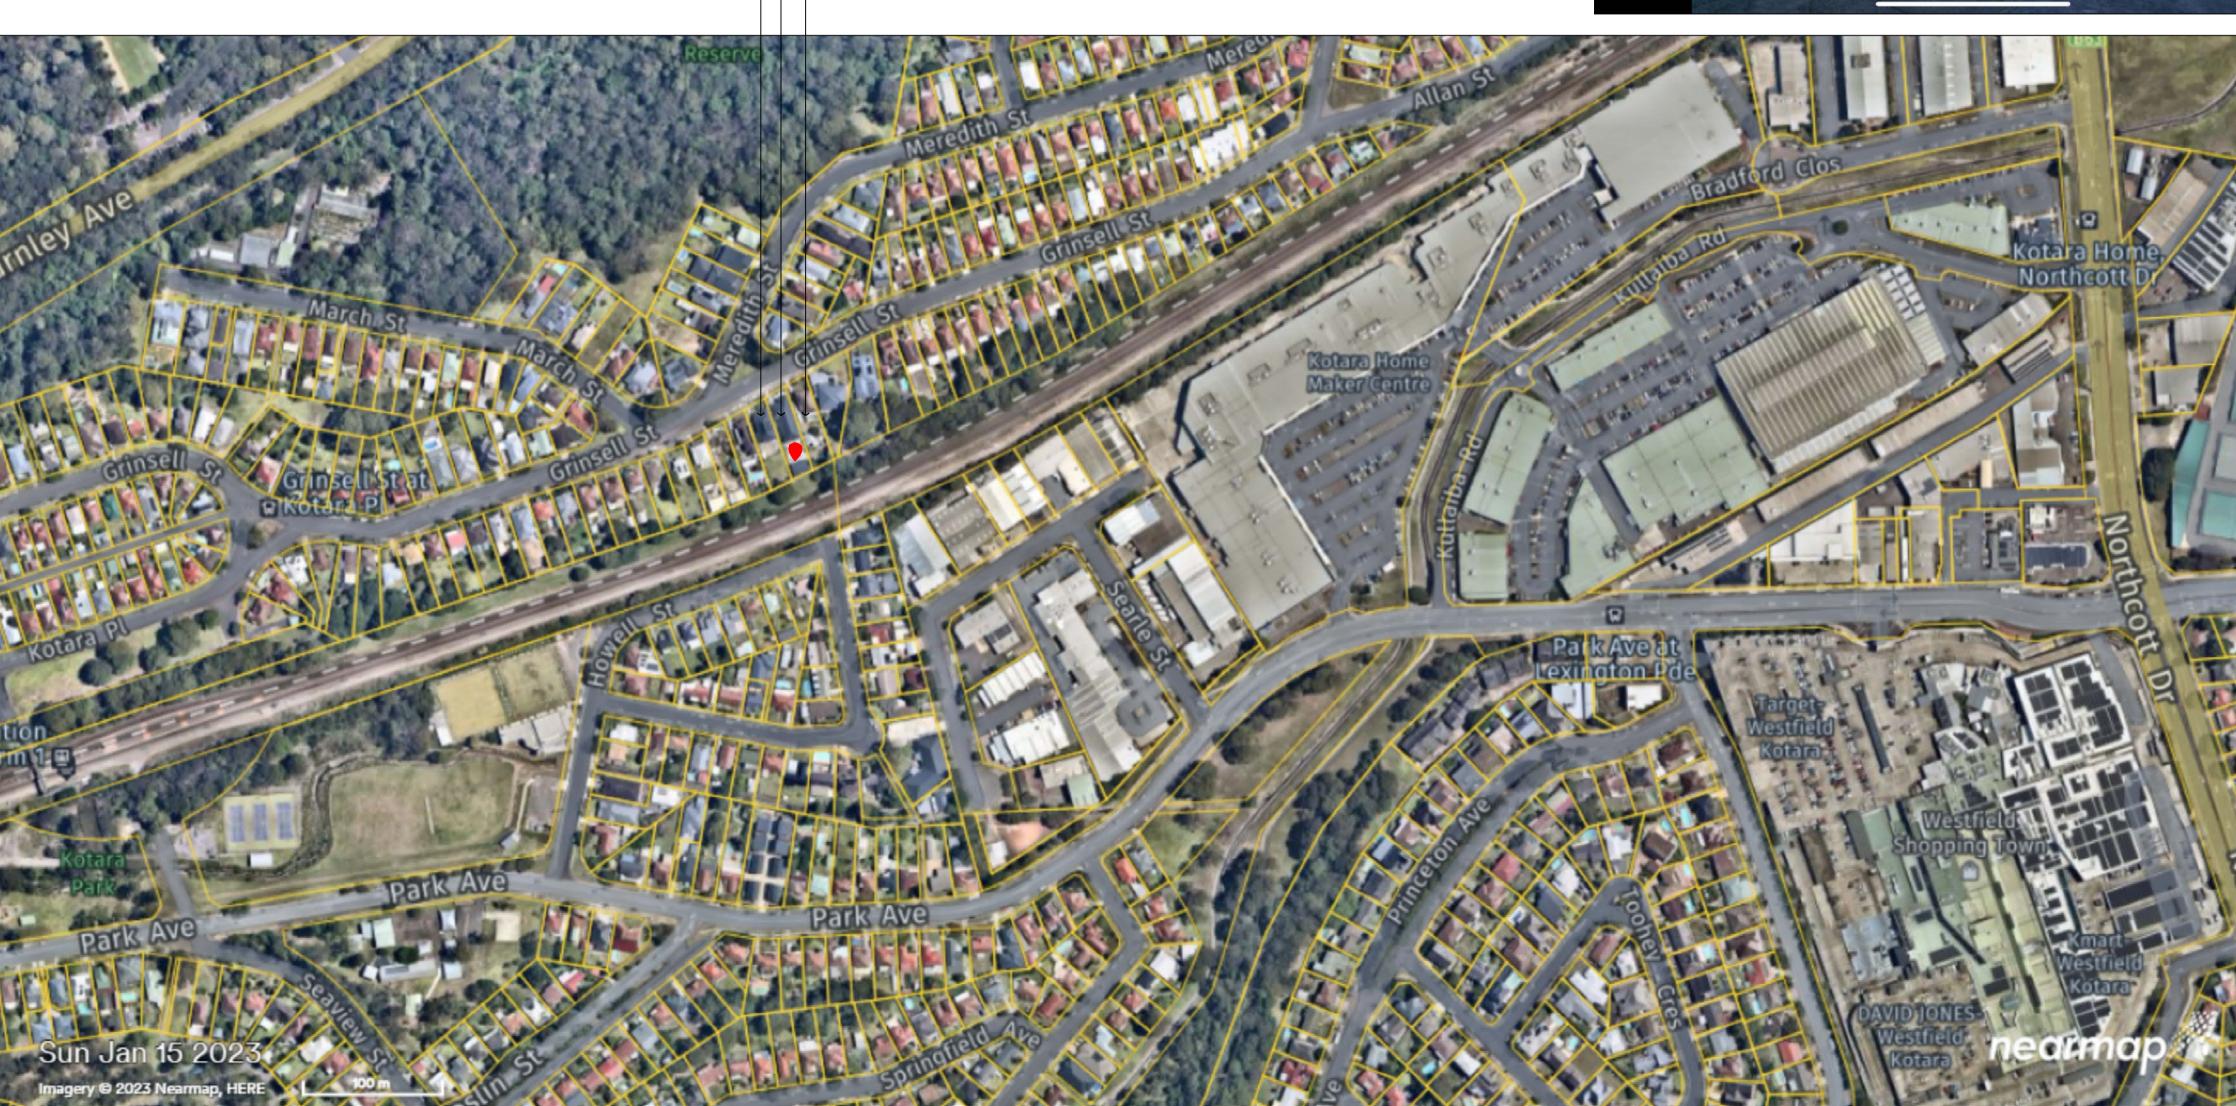

AERIAL VIEW OVER KOTARA

Issue.	Description	Date	Drawn	Chkd
С	ISSUE FOR CC	22.02.22	NLC	СВТ
D	WINDOW CHANGES	28.04.22	NLC	CBT
E	SECTION 4.55 MODIFICATION	12.08.22	NLC	СВТ
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I	SECTION C-C ADDED	15.09.23	NLC	CBT

W. & A. WATSON

WRITTEN DIMENSIONS TO TAKE PREFERENCE OVER SCALE

LOT 5, DP 18121 61 GRINSELL STREET KOTARA NSW 2289

SCALE 1:100

61 GRINSELL STREET

___ 59 GRINSELL STREET

63 GRINSELL STREET —

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Drawing Title	
VIEW	ANALYSIS
PLAN	

4000								
	Drawn	Date	Scale	A1	Checked		Date	l
V	NLC	14.09.2023		NTS	СВТ	15.0	9.2023	
*	Designed	Project No.			Dwg. No.		Issue	ı
ON	CBT	TD_	21/0)57	S4.55_	_09	I	


61 GRINSELL STREET KOTARA

Landscape Plan

Drawing Schedule

L01 Cover Sheet L02 Planting Plan



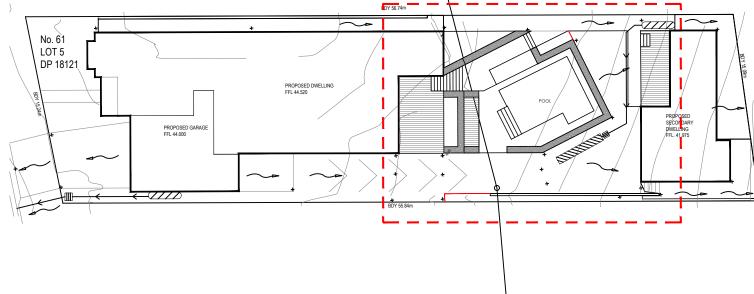

Refer to L02

Image sourced from Metromap 2023



Key Plan SCALE 1:300



3300	001111101113
Α	Issue for C
В	Issue for C

04.07.2023 07.09.2023 18.09.2023



michael@mwla.com.au 0448 051 302 www.mwla.com.au Suite 3A, 45 Hunter Street, Newcastle

Mr & Mrs Watson

drawn	checked	date created
AW	MW	03 July 2023
scale @ A Mr &	.3 Mrs Wat	

61 Grinsell Street	dro
site address 61 Grinsell Street, Kotara NSW	jok

Cover Sheet 2055 L01

PLANTING SCHEDULE					
Code	Quantity				
Aca lim	Acacia 'Lime Light'	200mm	4		
Ade ser	Adenanthos sericeis 'Platinum'	300mm	3		
Ban rol	Banksia 'Roller Coaster'	200mm	4		
Cal sli	Callistemon 'Slim'	300mm	19		
Cal swe	Callistemon 'Sweet'	200mm	5		
Iso liv	Isolepis 'Live Wire'	200mm	7		
Lom tan	Lomandra 'Tanika'	200mm	6		

<u>LEGEND</u> General Notes

Garden edge to Client's details

Pool Fence to Client's details


Sandstone log retaining wall


Pavement to Client's details


Timber Deck

-- GE ---

- The landscape plans are planting arrangement only. For all hard surface treatments refer to others.
- Refer to civil engineers plans for stormwater design, retaining wall details and grading.
- Allow for 100mm depth of turf underlay topsoil in all turf areas.
- Garden beds to have minimum 300mm depth garden mix topsoil.
- Refer to architectural plans for details of the timber decks.
- All pavement materials and finishes to be confirmed by the client. Pavement depth and structural details by others.
- Pool details and fencing by others.

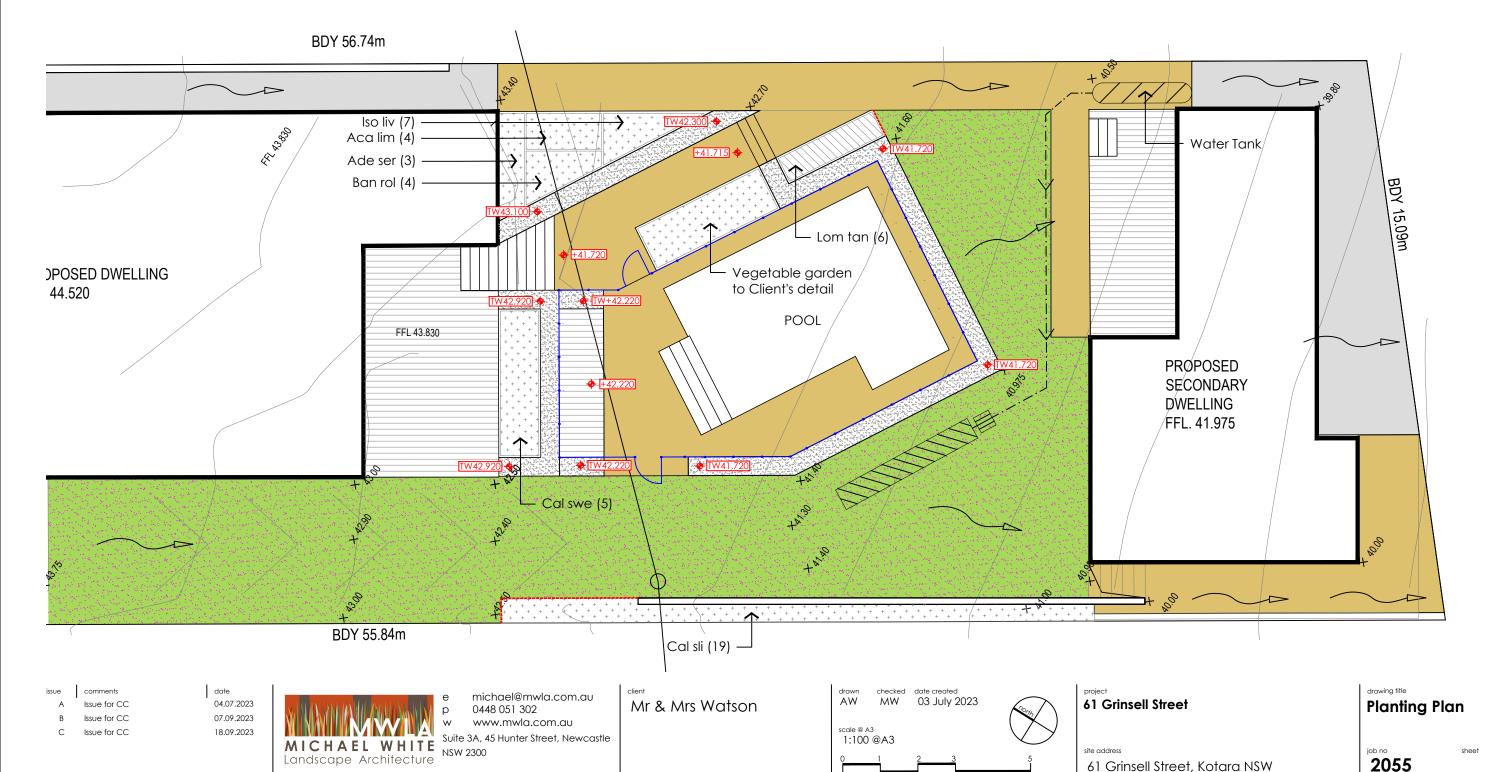

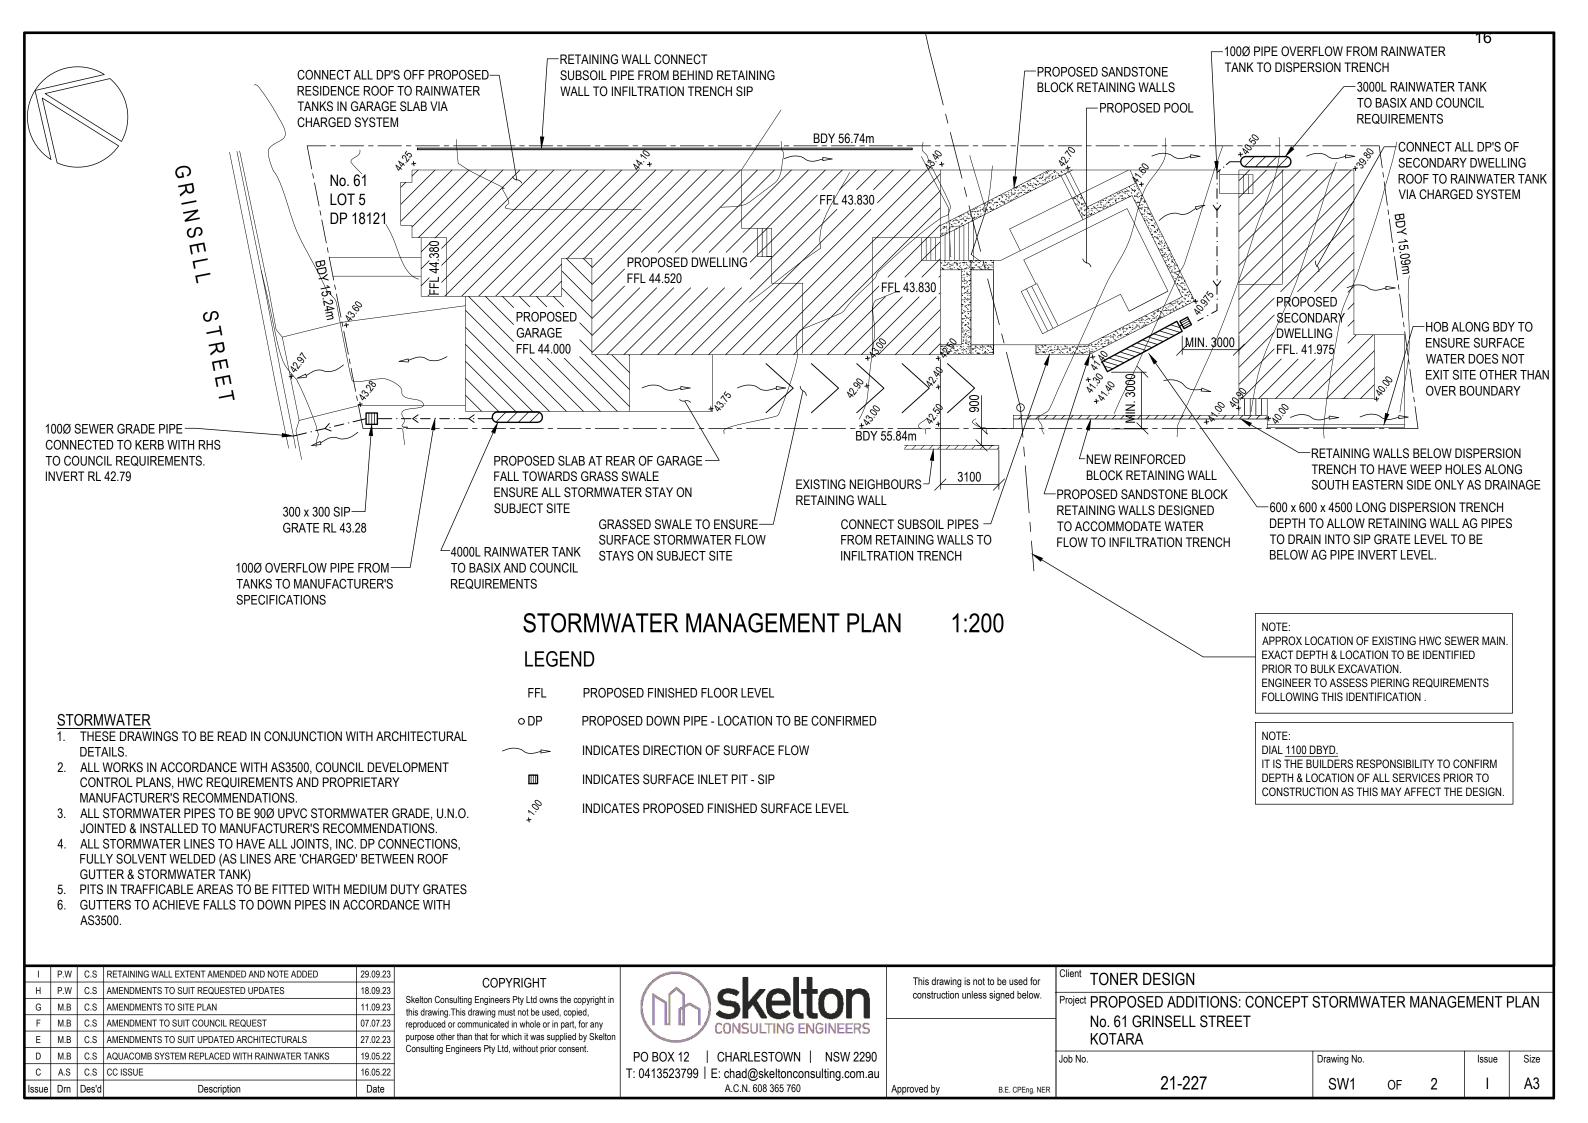

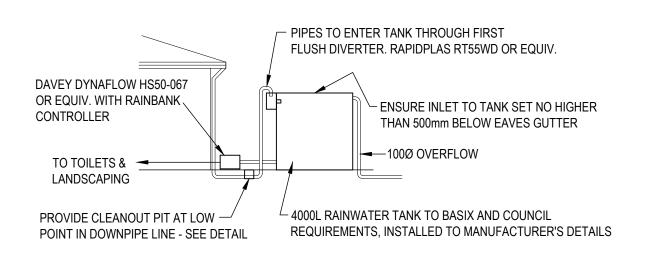

MAIN DWELLING RAINWATER TANK SCHEMATIC SECTION N.T.S

TANK SCHEMATIC SECTION N.T.S

SECONDARY DWELLING **GUTTER LEVEL R.L 43.9** PIPES TO ENTER TANK THROUGH FIRST FLUSH DIVERTER. RAPIDPLAS RT55WD OR EQUIV. PIPE INVERT R.L 42.9 ENSURE INLET TO TANK SET NO HIGHER THAN 500mm BELOW EAVES GUTTER OVERFLOW FROM TANK DAVEY DYNAFLOW HS50-067 **INVERT LEVEL R.L 42.6** OR EQUIV. WITH RAINBANK **CONTROLLER** -100Ø OVERFLOW -GRATE LEVEL R.L 41.3 TO TOILETS & LANDSCAPING DISPERSION TRENCH 3000L RAINWATER TANK TO BASIX AND COUNCIL PROVIDE CLEANOUT PIT AT LOW REQUIREMENTS, INSTALLED TO MANUFACTURER'S DETAILS POINT IN DOWNPIPE LINE - SEE DETAIL

SECONDARY DWELLING RAINWATER TANK SCHEMATIC SECTION N.T.S

CATCHMENT AREA TO DISPERSION TRENCH - SECONDARY DWELLING = 93m²

DISPERSION TRENCH LENGTH = 1m FOR EVER 25m² OF ROOF AREA LENGTH = 4m TO COMPLY WITH COUNCIL DCP.

NOM. 300SQ PIT SEALED CAP

CLEANOUT PIT DETAIL N.T.S

P.W C.S AMENDMENTS AS PER REQUESTED UPDATES 18.09.23 M.B | C.S | AMENDMENTS TO SUIT COUNCIL REQUEST 07.07.23 M.B | C.S | AMENDMENTS TO SUIT UPDATED ARCHITECTURALS 27.02.23 M.B C.S RAIN WATER TANKS ADDED 19.05.22 A.S C.S CC ISSUE 16.05.22 M.B | C.S | CHANGES TO SUIT GEOTECHNICAL RECOMMENDATIONS 29.09.21 M.B C.S DA ISSUE 01.06.21 ssue Drn Des'd Description

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Approved by

sed for Client TONER DESIGN

B.E. CPEng. NER

Project PROPOSED ADDITIONS: CONCEPT STORMWATER MANAGEMENT PLAN No. 61 GRINSELL STREET KOTARA

Job No.

21-227

Drawing No. Issue Size SW2 OF 2 G A3

DISPERSION TRENCH DETAIL N.T.S

SEDIMENT PIT

STORMWATER MANAGEMENT PLAN - SYDNEY TRAIN REQUESTED INFORMATION.

THE ORIGINAL SITE CONSISTS OF A RESIDENCE, GARAGE, DRIVEWAY AND RETAINING WALLS. ALL OF THE STORMWATER FROM THE SITE DRAINS TO THE REAR AND INTO THE RAIL CORRIDOR.

150mm COVER TO NATURAL SURFACE 75mm GRAVEL OVER GEOFABRIC

SLOTTED PIPE LAID

ACROSS THE FULL

LENGTH OF THE

TRENCH

FILL WITH COARSE GRAVEL (30mm)

GEOTEXTILE FABRIC ENVELOPE

SITE AREA = 841.61m² ORIGINAL IMPERVIOUS AREA = 289.23m².

DISPERSION TRENCH 600 x 600

x 4000 LONG

MESH SCREEN OVER

PIPE OUTLET

INFLOW FROM — GRASSED AREAS

INFLOW FROM

RAINWATER TANK

THE PROPOSED SITE CONSISTS OF OF A RESIDENCE, SECONDARY DWELLING AND RETAINING WALLS. THE STORMWATER OFF THE PROPOSED RESIDENCE WILL BE DIRECTED TO THE STREET VIA A RAINWATER TANK. THE STORMWATER OFF THE SECONDARY DWELLING WILL BE DIRECTED TO AN DISPERSION TRENCH VIA A RAINWATER TANK. OTHER STORMWATER FALLING ON NON-ROOF AREAS OF THE SITE WILL EXIT THE SITE INTO THE RAIL CORRIDOR AS OVERLAND FLOW.

PROPOSED RESIDENCE AREA = 329.32m²
PROPOSED SECONDARY DWELLING AREA = 93.03m².

THE PROPOSAL TO DIRECT THE STORMWATER OFF THE RESIDENCE TO THE STREET WILL SIGNIFICANTLY REDUCE THE RUNOFF FROM THE SITE ENTERING THE RAIL CORRIDOR. THE PROPOSAL TO DRAIN THE SECONDARY DWELLING TO AN DISPERSION TRENCH WILL FURTHER REDUCE THE FLOW FROM THE SITE TO THE RAIL CORRIDOR.


THE TOTAL SITE AREA DISCHARGING TO THE RAIL CORRIDOR WILL BE $\underline{\text{REDUCED}}$ BY $329.32\text{m}^2.$


ATTACHMENTS DISTRIBUTED UNDER SEPARATE COVER

PV 17/10/23 - 2/29 & 3/31 HONEYSUCKLE DRIVE NEWCASTLE - FOOD AND DRINK PREMISES - CHANGE OF USE AND FITOUT - DA2023/00243

6.2 Attachment A: Submitted Plans

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equipment and the preparation of shop drawings and / or the fabrication of any components.

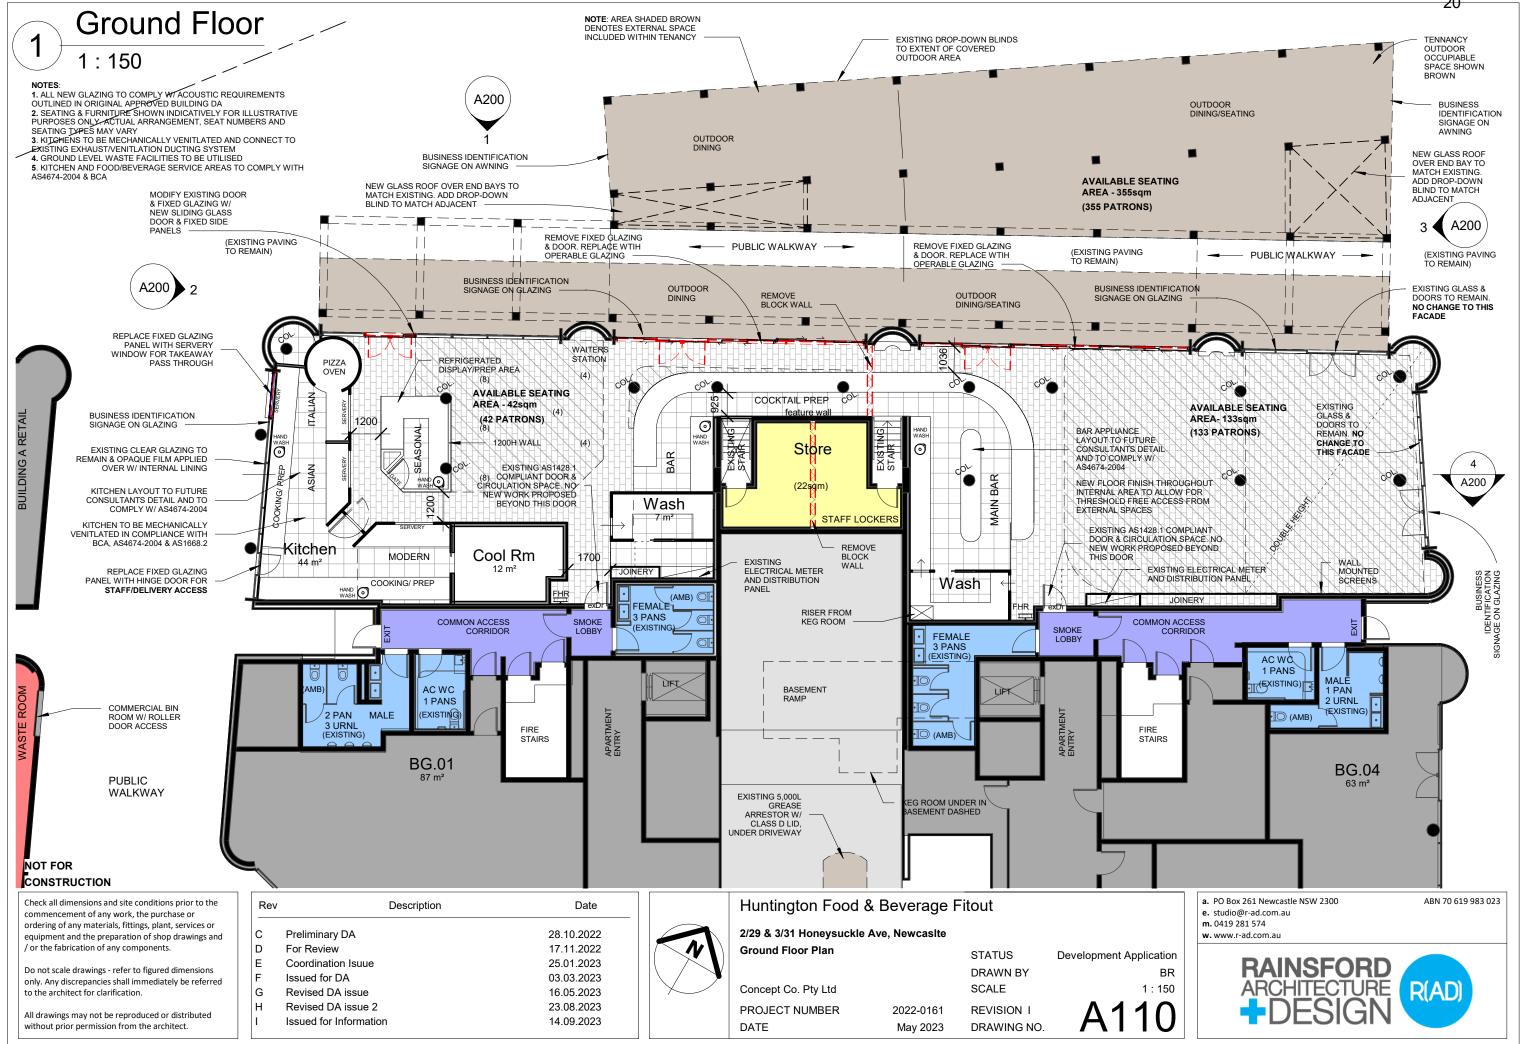Do not scale drawings - refer to figured dimensions only. Any discrepancies shall immediately be referred to the architect for clarification.

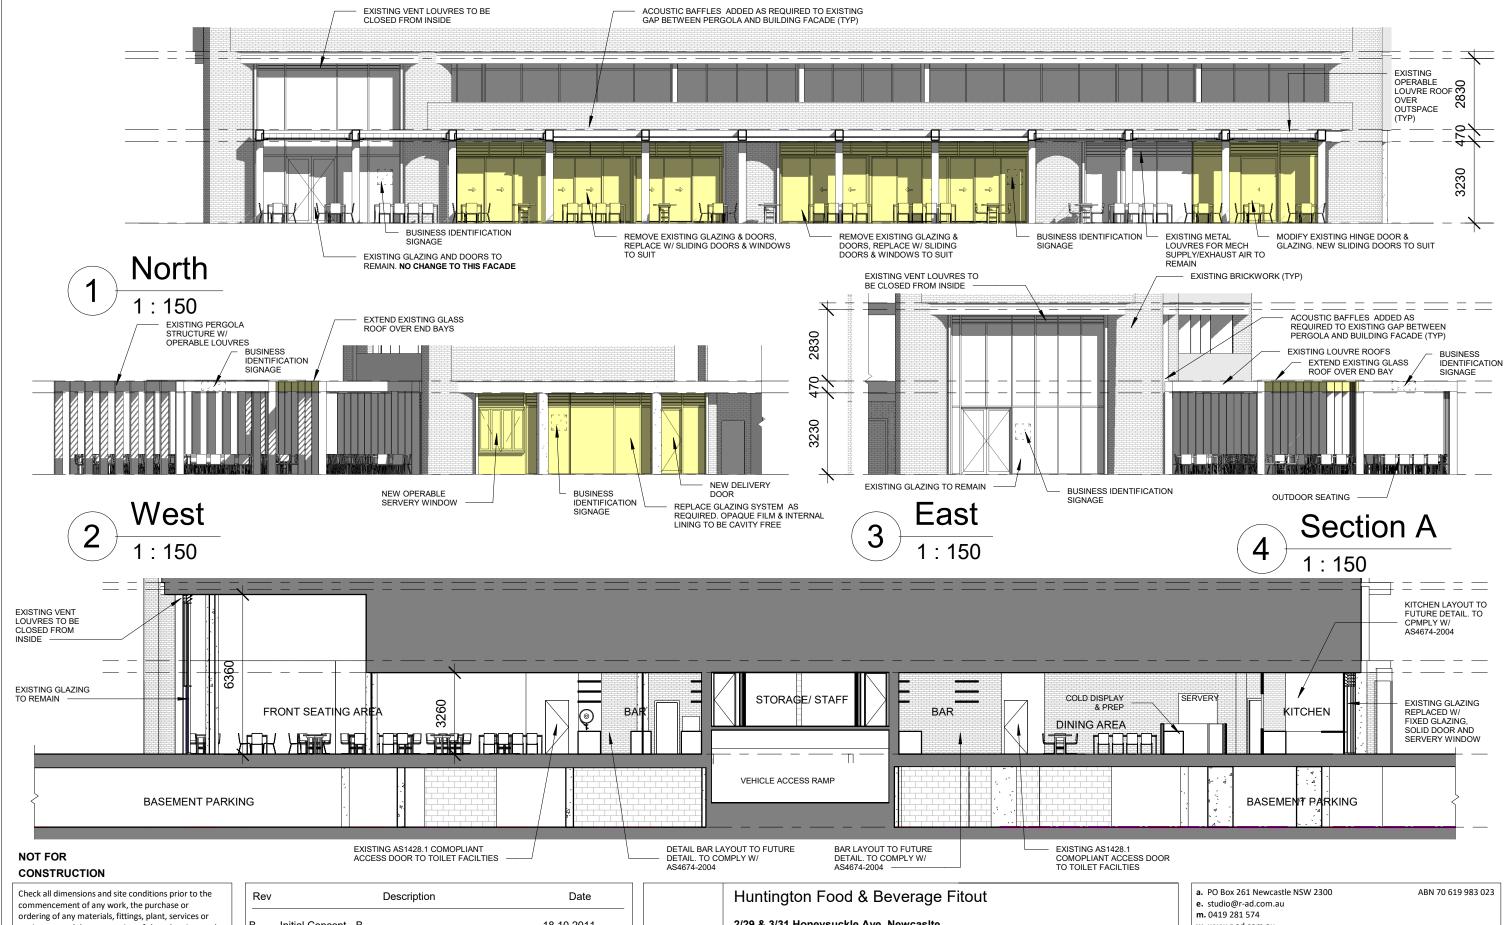All drawings may not be reproduced or distributed without prior permission from the architect.

Rev	Description	Date
В	Initial Concept - B	18.10.2011
С	Preliminary DA	28.10.2022
D	For Review	17.11.2022
E	Coordination Isuue	25.01.2023
F	Issued for DA	03.03.2023
G	Revised DA issue	16.05.2023
Н	Revised DA issue 2	23.08.2023

Huntington Food & Beverage Fitout					
2/29 & 3/31 Honeysuckle Ave, Newcasite					
Elevations & Section		STATUS	Development Application		
		DRAWN BY	BR		
Concept Co. Pty Ltd		SCALE	1 : 150		
PROJECT NUMBER	2022-0161	REVISION H	A200		
DATE	May 2023	DRAWING NO.	AZUU		

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