ATTACHMENTS DISTRIBUTED UNDER SEPARATE COVER

DAC 06/12/22 – 26 WOODWARD STREET MEREWETHER – DA2022/00382 AND DUAL OCCUPANCY – INCLUDES DEMOLITION AND SUBDIVISION (2 LOTS) TORRENS TITLE

PAGE 5	ITEM-25	Attachment A:	Submitted Plans
PAGE 41	ITEM-25	Attachment B:	Draft Schedule of Conditions
PAGE 55	ITEM-25	Attachment C:	Processing Chronology
PAGE 58	ITEM-25	Attachment D:	Subsidence Advisory NSW approval
PAGE 64	ITEM-25	Attachment E:	Clause 4.6 variation request

ATTACHMENTS DISTRIBUTED UNDER SEPARATE COVER

DAC 06/12/22 – 26 WOODWARD STREET MEREWETHER – DA2022/00382 AND DUAL OCCUPANCY – INCLUDES DEMOLITION AND SUBDIVISION (2 LOTS) TORRENS TITLE

ITEM-25 Attachment A: Submitted Plans

Council Submission

Project Location:

26 Woodward Street Merewether 2291

Client

Nicole & Stephen

Drawing Catalogue: (Survey By Others)

DA-000 Cover Page DA-001 Site Analysis Plan DA-002 Site Plan DA-003 Site Coverage DA-004 Perspectives DA-005 Perspectives Dwelling One Plans DA-100 DA-101 Dwelling One Plans DA-102 **Dwelling Two Plans** DA-103 Dwelling Two Plans DA-104 **Dwelling Two Plans** DA-105 Dwelling Two Plans DA-300 DA-301 Elevations DA-302 Elevations DA-303 Elevations DA-304 Elevations DA-305 Elevations - Street DA-400 Sections DA-401 Sections DA-402 DA-500 Shadow Diagrams - JUN 21st DA-501 Shadow Diagrams - JUN 21st DA-502 Shadow Diagrams - DEC 21st DA-503 Perspective Shadow Diagrams DA-504 Perspective Shadow Diagrams DA-505 Perspective Shadow Diagrams Perspective Shadow Diagrams



e: joel@shadedesign.net.au

BASIX

Area Schedules

m: 0412 879 643

DA-700

DA-800



SUBJECT SITE - NTS




LOCATION - NTS


Site Information

Client
Nicole & Stephen
Site Address
26 Woodward Street Merewether 2291
Sec -, Lot 48, DP 39230, SP -

LGANewcastleLand ZoningR2PrecinctLimitedFSR/Site Coverage0.6Maximum Height8.5

Flood Area no
Mine Subsidence Area Yes
Bushfire Area no
Heritage Area no

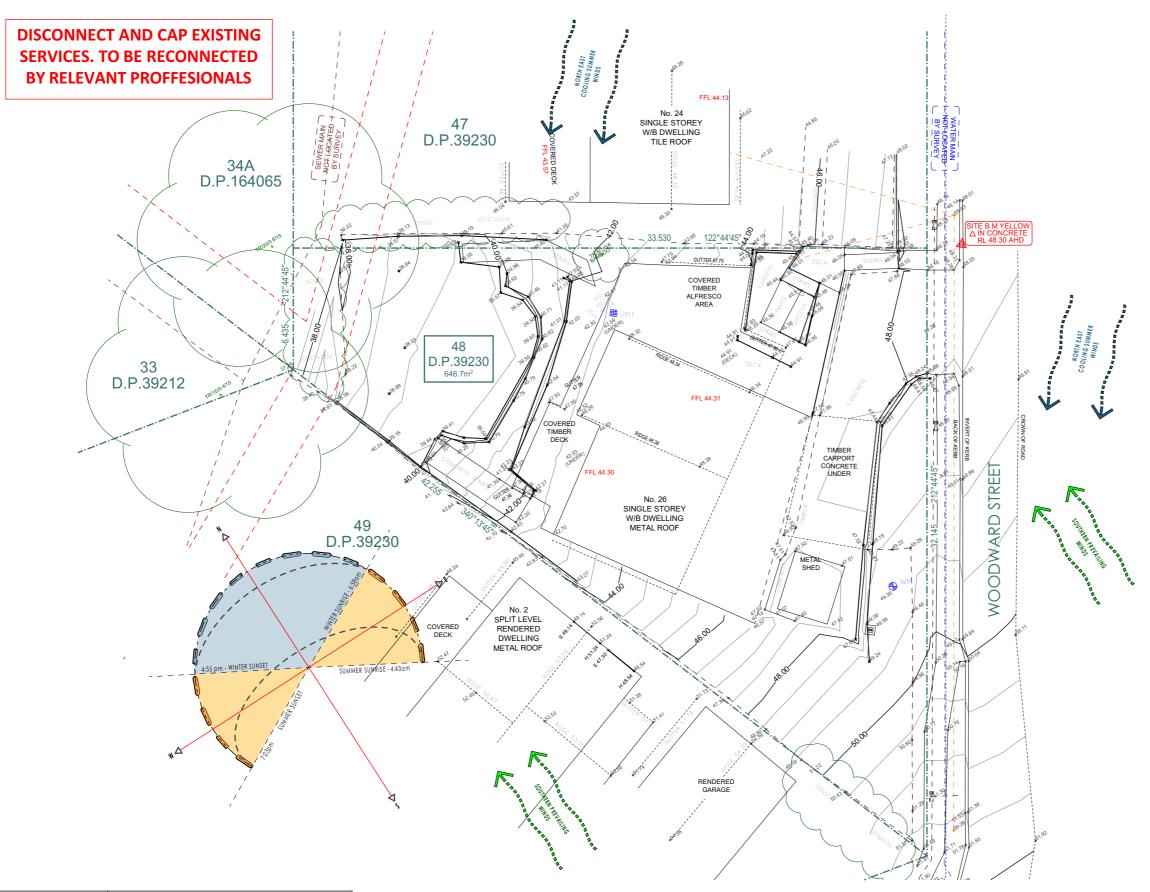

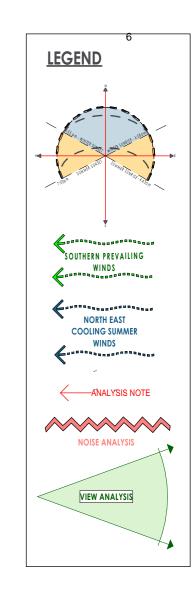

W-01	SITE ANALYSIS
1:200	

26 Woodward Street Merewether 2291

Nicole & Stephen





Drawing		
Site Analysis Plan		
0110 7 11 101 1 101 1		
Drawing No.		
DA-001		

Project Number 2168 Scale

As Shown @ A3

Council Submission Council RFI



LEGEND

Site Area	646m²
Floor Area (GFA)	
Dwelling 01	180m²
Dwelling 02	191m²
Total Floor Area (GFA) Floor Space Ratio (Max 0.6 = 387m²)	371m² 0.57:1
R2 - Limited Growth	
landscape Area (30% Min Req. = 193m²)	263m² 40%
Deep Soil Area (15% Min Req. = 96m²)	150m² 15%

STORMWATER

PLEASE REFER TO CONSULTING ENGINEERS
DRAWINGS FOR STORMWATER DETAILS AS REQUIRED



CALCULATED LANDSCAPED AREAS



DEEP SOIL AREAS



PRICIPLE PRIVATE OPEN SPACE



BUILDING FOOTPRINT

NOTES

VERTICAL CONTROL JOINTS INDICATIVE ONLY LOCATED IN ALL EXTERNAL WALLS 5000-6000mm CTS MAX AS PER ENGINEERS
SPECIFICATIONS (BUILDER TO
CONFIRM LOCATIONS)

DOWNPIPE POSITIONS ARE INDICATIVE ONLY, POSITION OF DOWNPIPES TO BE CONFIRMED BY

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- SETBACKS ARE APPROXIMATES ONLY & BASED OF CURRENT SURVEYORS DOCUMENTATION AT THE TIME OF BEING ISSUED TO THE DESIGNER WITH THE CONCEPT DESIGNS - ALL SITE BOUNDARIES ARE TO BE CONFIMED BY THE SURVEYOR PRIOR TO & DURING CONSTRUCTION - ALL SETBACKS ARE TO BE CONFRIRMED ON SITE BY THE SURVEYOR PRIOR TO & DURING CONSTRUCTION - ANY SITE/SURVEY DISCREPENCIES ARE TO BE REPORTED TO SHADE DESIGN NEWCASTLE PTY LTD IMMEDIATLY

DIAL1100 BEFORE YOU DIG

SURVEY BY OTHERS

Woodward Street Dual Occupancy

26 Woodward Street Merewether 2291

Site Plan

Nicole & Stephen

1:200





Drawing Site Plan Drawing No. DA-002

FFL 44,13

122°44'45" 5°

DWELLING 01

RENDERED

DWELLING 02

BIN STORAGE SPACE

TO HAVE DECORATIVE SCREENING FORWARD

OF BUILDING LINE

No. 24

SINGLE STOREY

W/B DWELLING

TILE ROOF

33.530

D.P.39230

GRASSED AREA

COVERED DECK

POOL

Ó,678

POOL

GRASSE AREA

SPLIT LEVEL

RENDERED

METAL ROOF

EXISTING RETAINING WALL

48

D.P.39230 646.7m²

EXISTING RETAINING WALL

49 D.P.39230

SELECTED 1800mm HIGH COLORBOND BOUNDARY FENCE AS REQUIRED

34A

D.P.164065

SELECTED 1800mm HIGH

AS REQUIRED

COLORBOND BOUNDARY FENCE

33

D.P.39212

Project Number 2168 Scale

As Shown @ A3

Description Council Submission Council RFI

ΊШ

ST

2

WOODWA

2.400

PROPOSED VEHICLE CROSSING TO

CURRENT COUNCIL REQUIREMENTS

DECORTATIVE BLOCKWORK FENCE FORWARD OF THE BUILDING LINE

SELECTED 1200mm HIGH DECORTATIVE FENCE



LEGEND

Site Area	646m²
Floor Area (GFA)	
Dwelling 01	180m²
Dwelling 02	191m²
Total Floor Area (GFA) Floor Space Ratio (Max 0.6 = 387m²)	371m² 0.57:1
R2 - Limited Growth	
landscape Area (30% Min Req. = 193m²)	263m² 40%
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STORMWATER

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DRAWINGS FOR STORMWATER DETAILS AS REQUIRED



CALCULATED LANDSCAPED AREAS



DEEP SOIL AREAS



PRICIPLE PRIVATE OPEN SPACE



BUILDING FOOTPRINT

NOTES

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SURVEY BY OTHERS

Woodward Street Dual Occupancy

26 Woodward Street Merewether 2291

Site Coverage

Nicole & Stephen

1:200



A: 114 m²

GRASSED AREA

POOL

GRASSED AREA

A: 36 m

POOL

//////////////A: 16 m²



	Drawing
\rightarrow	Site Coverag
	Drawing No.
	DA-003
	I

ge

REFER TO LOWER LEVEL PLAN FOR DECK AREA OF PPOS

DWELLING 01

DWELLING 02

A: 14 m²

Project Number 2168

.. IF STREET

A: 27 m²

-A: 5 m²--

STREET

WOODWARD

Scale As Shown @ A3 Description Council Submission Council RFI





ARTISTS IMPRESSION

Woodward Street
Dual Occupancy

26 Woodward Street Merewether 2291

Nicole & Stephen



Perspectives 2168

Drawing No. Scale

DA-004

Scale As Shown @ A3 A Council Submission 28.03.22 26.10.22 Sin C



NOTES





Project Woodward Street **Dual Occupancy**

26 Woodward Street Merewether 2291

Nicole & Stephen





Drawing Perspectives

Drawing No. DA-005 Project Number 2168

Scale As Shown @ A3 Council Submission Council RFI



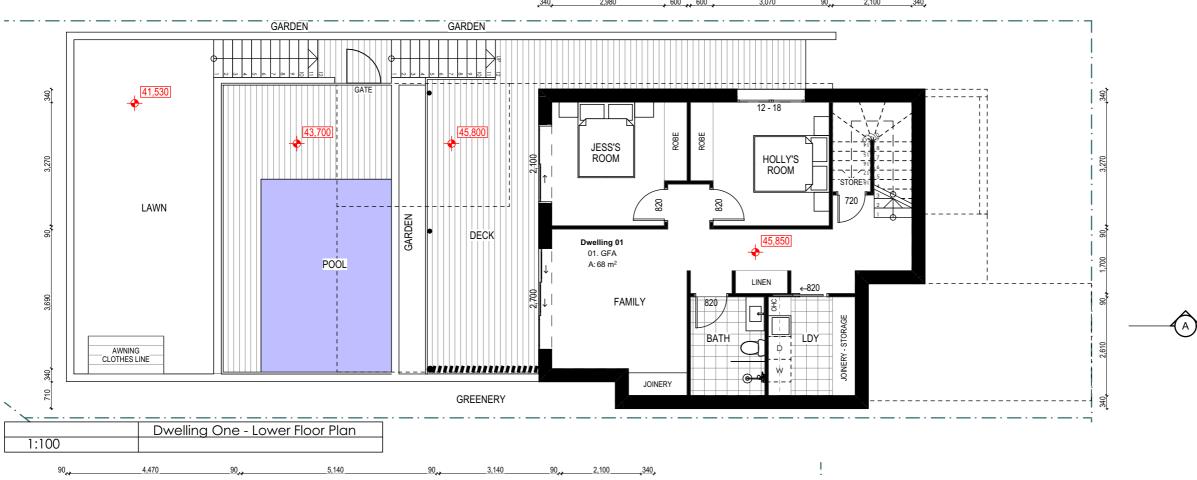

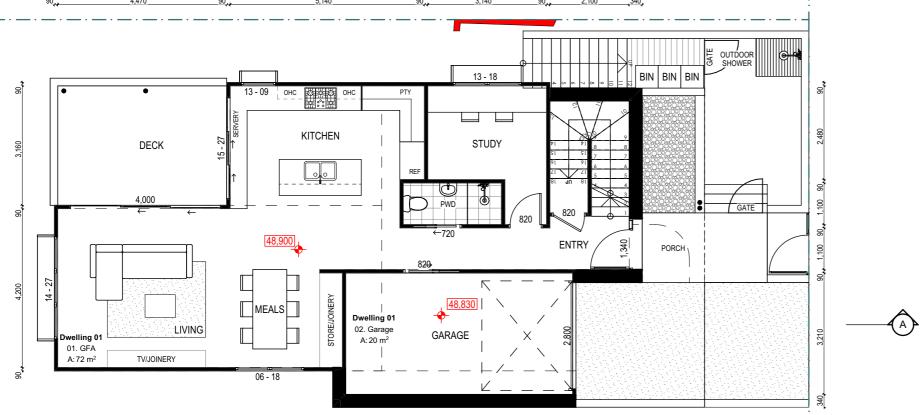

	Dwelling One - Lower Floor Plan
1.100	

26 Woodward Street Merewether 2291

Nicole & Stephen





Dwelling One Plans Drawing No. DA-100

Project Number 2168 Scale As Shown @ A3

Description Council Submission Council RFI

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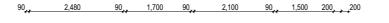
TO & DURING CONSTRUCTION


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- NOTES:
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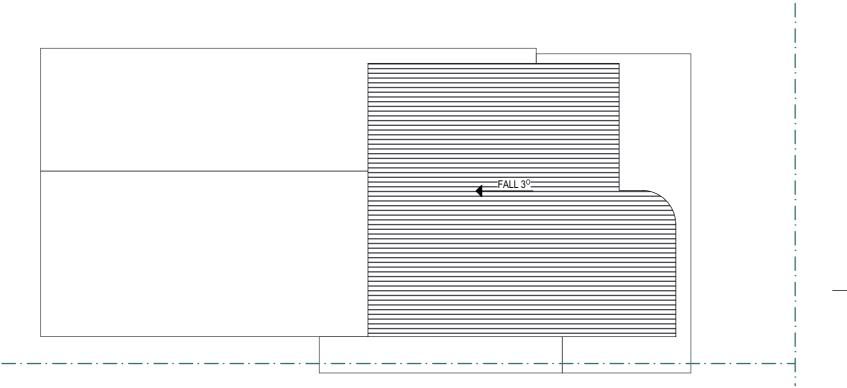
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	Dwelling One - First Floor Plan
1.100	



	Dwelling One - Roof Plan
1:100	

26 Woodward Street Merewether 2291 Nicole & Stephen



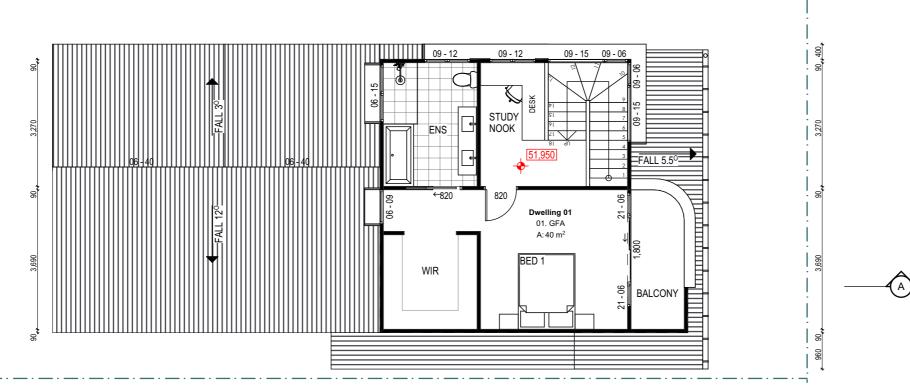

Drawing
Dwelling One Plans
-
Drawing No.
DA-101

Project Number 2168 Scale As Shown @ A3

evision	Description	Date
	Council Submission	28.03.22
	Council RFI	26.10.22

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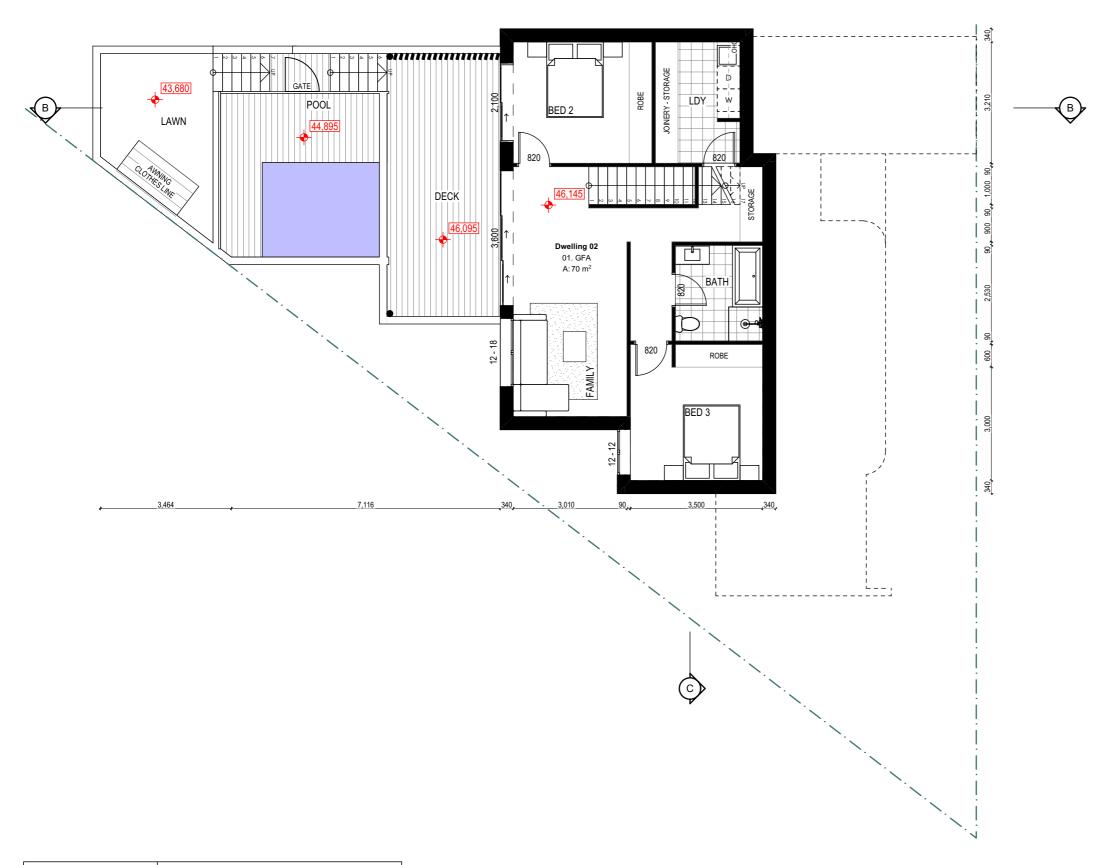
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	Dwelling Two - Lower Floor Plan
1:100	-

26 Woodward Street Merewether 2291

Nicole & Stephen



Dwelling Two Plans Drawing No. DA-102

Project Number 2168 Scale As Shown @ A3

/ision	Description	Date
	Council Submission	28.03
	Council RFI	26.10

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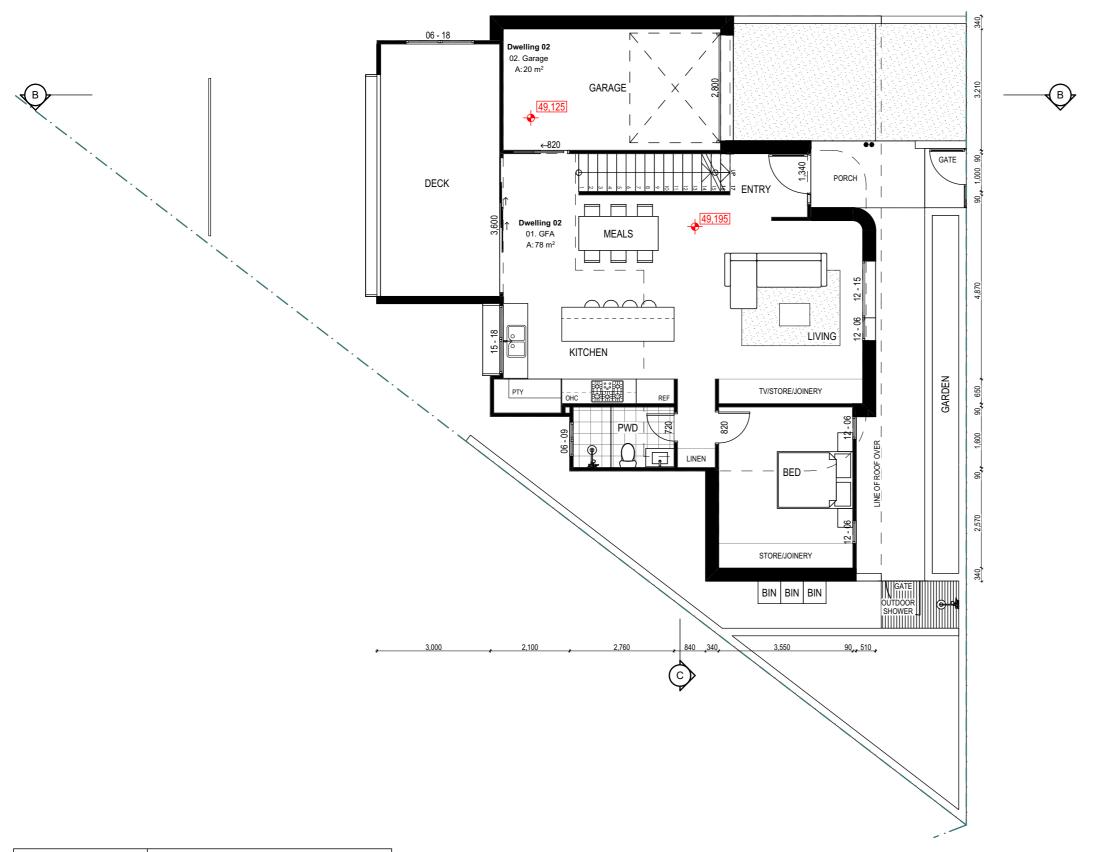
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	Dwelling Two - Ground Floor Plan
1:100	-

26 Woodward Street Merewether 2291

Nicole & Stephen





Dwelling Two Plans Drawing No. DA-103

Project Number 2168 Scale As Shown @ A3

Description Council Submission Council RFI

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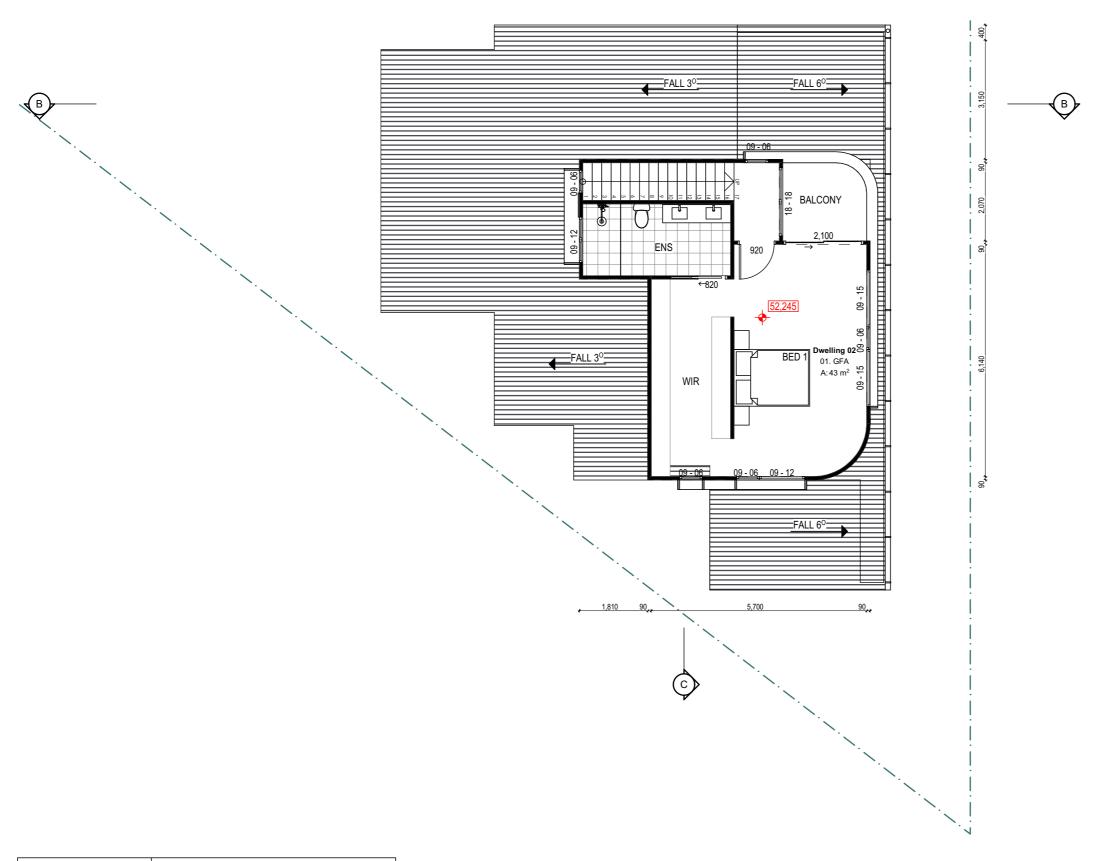
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	Dwelling Two - First Floor Plan
1:100	-

26 Woodward Street Merewether 2291

Nicole & Stephen



Dwelling Two Plans Drawing No. DA-104

Project Number 2168 Scale As Shown @ A3

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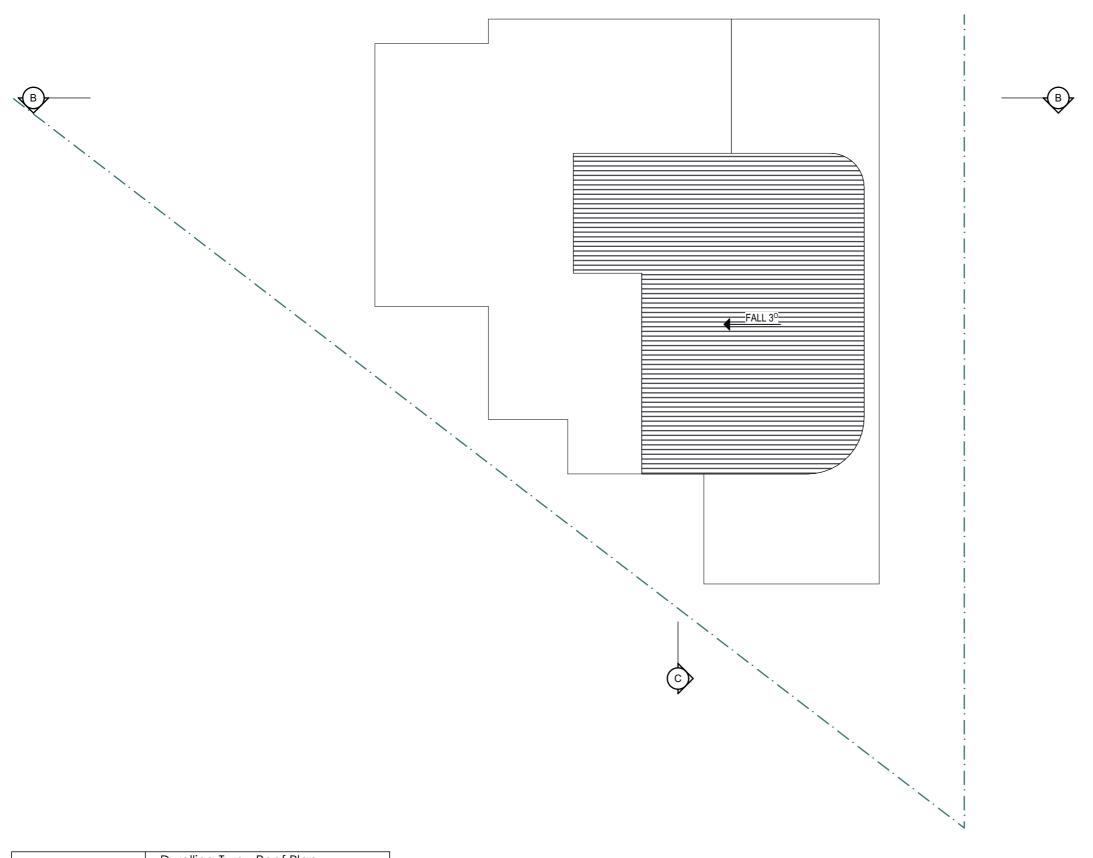
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	Dwelling Iwo - Roof Plan
1:100	

26 Woodward Street Merewether 2291

Nicole & Stephen



Dwelling Two Plans Drawing No.

DA-105

Project Number 2168 Scale

As Shown @ A3

Council Submission Council RFI

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CONFIRM BUILDING DIMENSIONS PRIOR

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SELECTED COLORBOND CUSTOM ORB METAL ROOF SHEETING



SELECTED APPLIED FINISH



SELECTED FACE BRICKWORK



SELECTED HORIZONTAL WALL CLADDING



SELECTED LIGHTWEIGHT VERTICAL WALL CLADDING

NOTES

VERTICAL CONTROL JOINTS INDICATIVE ONLY LOCATED IN ALL EXTERNAL WALLS 5000-6000mm CTS MAX AS PER ENGINEERS SPECIFICATIONS (BUILDER TO CONFIRM LOCATIONS)

DOWNPIPE POSITIONS ARE INDICATIVE ONLY, POSITION OF DOWNPIPES TO BE CONFIRMED BY BUILDER



1:100	E-01	SOUTH EAST ELEVATION
	1:100	

CONFIRM BUILDING DIMENSIONS PRIOR TO & DURING CONSTRUCTION

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Woodward Street Dual Occupancy

26 Woodward Street Merewether 2291

Nicole & Stephen



Drawing Elevations Drawing No. DA-300

Project Number 2168 Scale

As Shown @ A3

Description Council Submission Council RFI


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Woodward Street Dual Occupancy

26 Woodward Street Merewether 2291

Nicole & Stephen



Drawing
Elevations
Drawing No.
DA-301

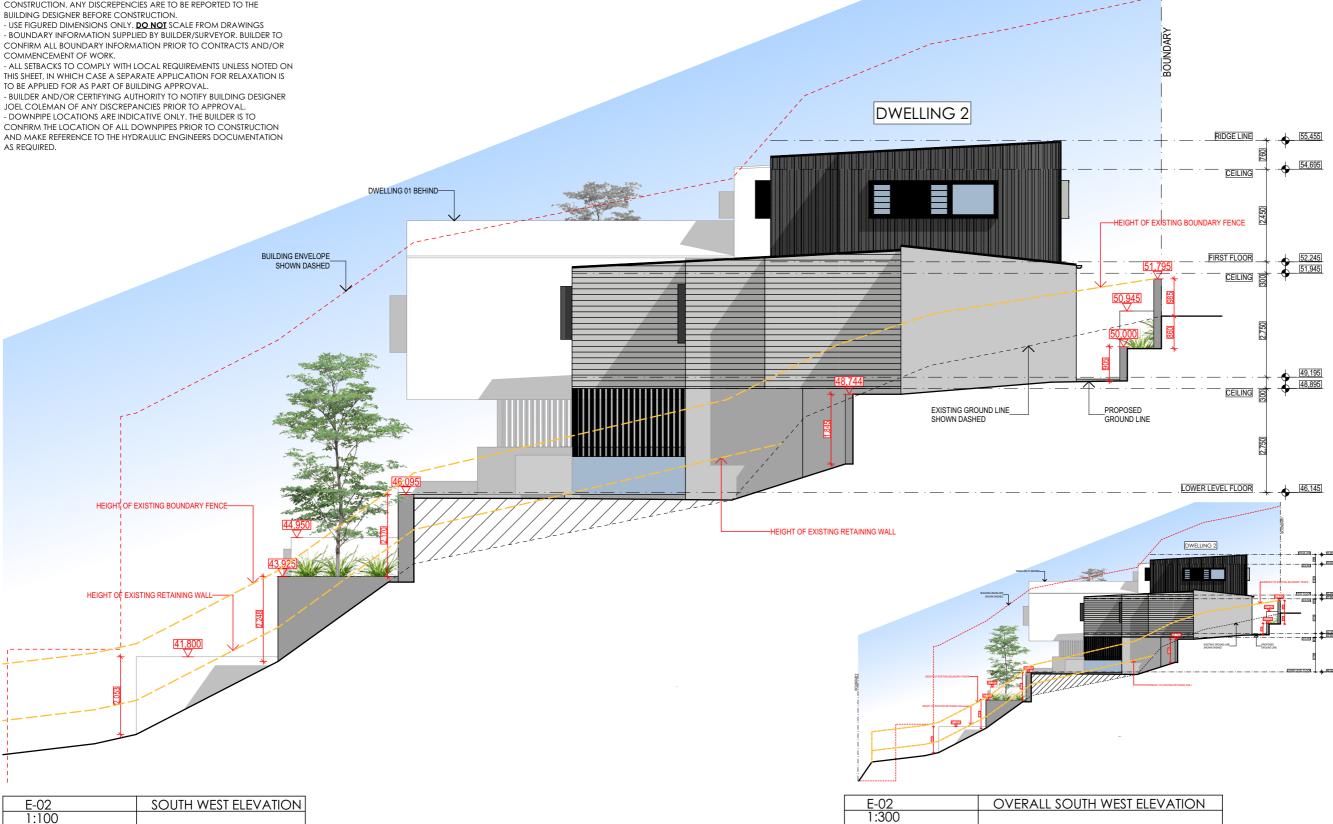Project Number	
2168	
Scale	
As Shown @ A3	\vdash

Revision A B	Description Council Submission Council RFI	Date 28.03.22 26.10.22	S	hc
FOR AUTH	ORITY APPROVAL ONLY (NOT FOR CON	STRUCTION)	e: m:	joel@shadedes 0412 879 643



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LEGEND

SELECTED COLORBOND CUSTOM ORB METAL ROOF SHEETING

SELECTED APPLIED FINISH

SELECTED FACE BRICKWORK

SELECTED HORIZONTAL WALL CLADDING

SELECTED LIGHTWEIGHT VERTICAL WALL CLADDING

NOTES

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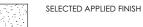
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LEGEND







SELECTED FACE BRICKWORK



SELECTED HORIZONTAL WALL CLADDING



SELECTED LIGHTWEIGHT VERTICAL WALL CLADDING

NOTES

VERTICAL CONTROL JOINTS INDICATIVE ONLY LOCATED IN ALL EXTERNAL WALLS 5000-6000mm CTS MAX AS PER ENGINEERS SPECIFICATIONS (BUILDER TO CONFIRM LOCATIONS)

DOWNPIPE POSITIONS ARE INDICATIVE ONLY, POSITION OF DOWNPIPES TO BE CONFIRMED BY BUILDER



E-03	OVERALL NORTH WEST ELEVATION
1:200	

Project Number 2168 Scale	Revision A B	Description Council Submission Council RFI	Date 28.03.22 26.10.22	S	hade
As Shown @ A3	FOR AUTH	ORITY APPROVAL ONLY (NOT	FOR CONSTRUCTION)	e: m:	joel@shadedesign.net.au 0412 879 643

Woodward Street Dual Occupancy

26 Woodward Street Merewether 2291

NORTH WEST ELEVATION

Nicole & Stephen

55,185 RIDGE

CEILING

51,950 FIRST FLOOR

CEILING

48,900 GROUND FLOOR

45,850 LOWER LEVEL FLOOR

43,700 POOL DECK

41,800 LAWN

51,650

EXISTING GROUND LINE



39,041

DWELLING 01

Drawing Elevations

EVATIONS

303

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 \bigcirc

RAWING

Drawing No. DA-302

CONFIRM BUILDING DIMENSIONS PRIOR TO & DURING CONSTRUCTION

55,450

54,695

52,220

51,920

RIDGE

CEILING

FIRST FLOOR.

GROUND FLOOR

EIGHT OF EXISTING BOUNDARY FENCE

EXISTING GROUND LINE -ALONG BOUNDARY

CEILING

- NOTES:
 BUILDER TO CONFIRM LEVELS AND DIMENSIONS PRIOR TO AND DURING CONSTRUCTION. ANY DISCREPENCIES ARE TO BE REPORTED TO THE
- BUILDING DESIGNER BEFORE CONSTRUCTION.


 USE FIGURED DIMENSIONS ONLY. <u>DO NOT</u> SCALE FROM DRAWINGS

 BOUNDARY INFORMATION SUPPLIED BY BUILDER/SURVEYOR. BUILDER TO CONFIRM ALL BOUNDARY INFORMATION PRIOR TO CONTRACTS AND/OR COMMENCEMENT OF WORK.

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LEGEND



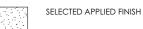

SELECTED FACE BRICKWORK



SELECTED LIGHTWEIGHT VERTICAL WALL CLADDING



VERTICAL CONTROL JOINTS INDICATIVE ONLY LOCATED IN ALL EXTERNAL WALLS 5000-6000mm CTS MAX AS PER ENGINEERS SPECIFICATIONS (BUILDER TO CONFIRM LOCATIONS)

DOWNPIPE POSITIONS ARE INDICATIVE ONLY, POSITION OF DOWNPIPES TO BE CONFIRMED BY BUILDER



Woodward Street Dual Occupancy

E-03 1:100

ELEVATIONS

3-302 [

DA

Z

CONTINUED

DRAWING

26 Woodward Street Merewether 2291 Nicole & Stephen

0007170250 28 Mar 2022

NORTH WEST ELEVATION

DWELLING 02

Drawing Elevations Drawing No. DA-303

EXISTING GROUND LINE

HEIGHT OF EXISTING RETAINING WALL

Project Number 2168

Scale As Shown @ A3 Description Council Submission Council RFI

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CONFIRM BUILDING DIMENSIONS PRIOR TO & DURING CONSTRUCTION

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LEGEND

SELECTED COLORBOND CUSTOM ORB METAL ROOF SHEETING



SELECTED APPLIED FINISH



SELECTED FACE BRICKWORK




SELECTED HORIZONTAL WALL CLADDING

SELECTED LIGHTWEIGHT VERTICAL WALL CLADDING

VERTICAL CONTROL JOINTS
INDICATIVE ONLY LOCATED IN ALL
EXTERNAL WALLS 5000-6000mm CTS
MAX AS PER ENGINEERS
SPECIFICATIONS (BUILDER TO
CONFIRM LOCATIONS)

DOWNPIPE POSITIONS ARE INDICATIVE ONLY, POSITION OF DOWNPIPES TO BE CONFIRMED BY

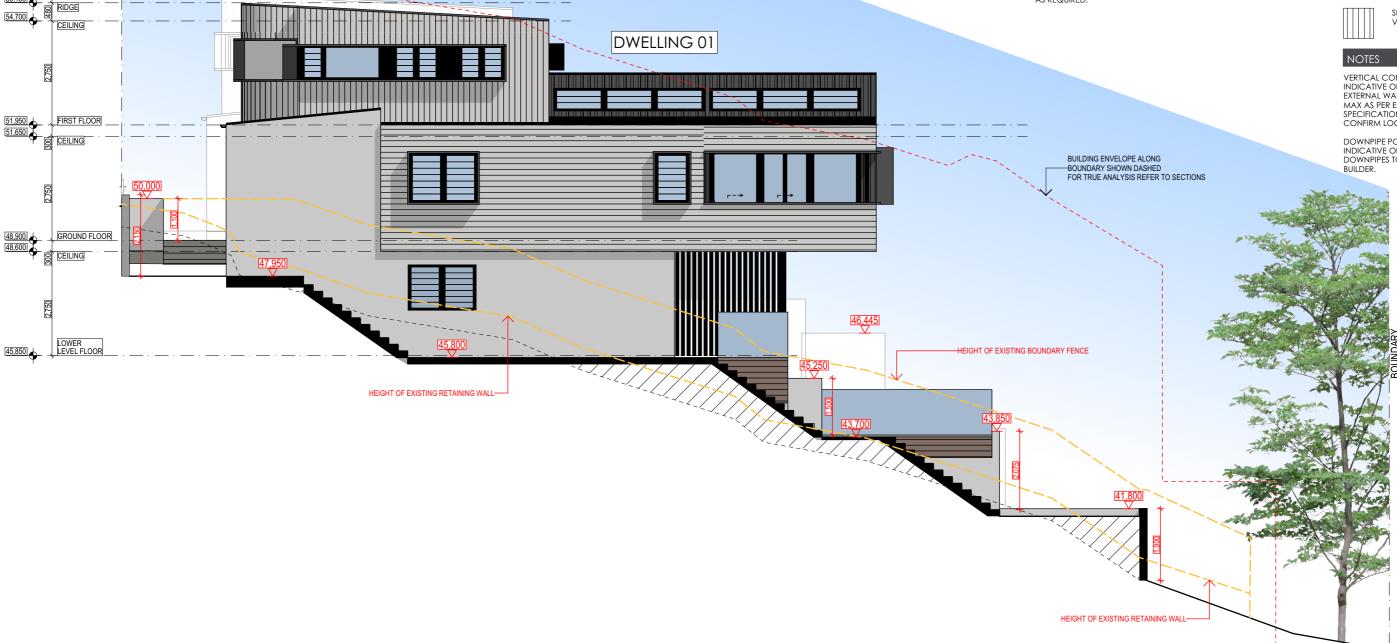

E-04	NORTH EAST ELEVATION
1:100	

Woodward Street Dual Occupancy

26 Woodward Street Merewether 2291

Nicole & Stephen

ALL I	0007170250 28 Mar 2022
NATIONWIDE	Assessor Joseph Lorriman Accreditation No. DMN/16/1742 Address
HOUSE INTEGRALING SCHEME	26 Woodward Street , MEREWETHER , NSW , 2291
	hstar.com

HATCHED BEHIND

Drawing
Elevations
Drawing No.
DA-304

Project Number

Project Number	Revision	Description	Date		
2168	A B	Council Submission Council RFI	28.03.22 26.10.22	S	chc
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TO & DURING CONSTRUCTION

NOTES:
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CONFIRM BUILDING DIMENSIONS PRIOR

LEGEND

SELECTED COLORBOND CUSTOM ORB METAL ROOF SHEETING



SELECTED APPLIED FINISH



SELECTED FACE BRICKWORK




SELECTED HORIZONTAL WALL CLADDING



SELECTED LIGHTWEIGHT VERTICAL WALL CLADDING

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MAX AS PER ENGINEERS
SPECIFICATIONS (BUILDER TO
CONFIRM LOCATIONS)

DOWNPIPE POSITIONS ARE INDICATIVE ONLY, POSITION OF DOWNPIPES TO BE CONFIRMED BY BUILDER

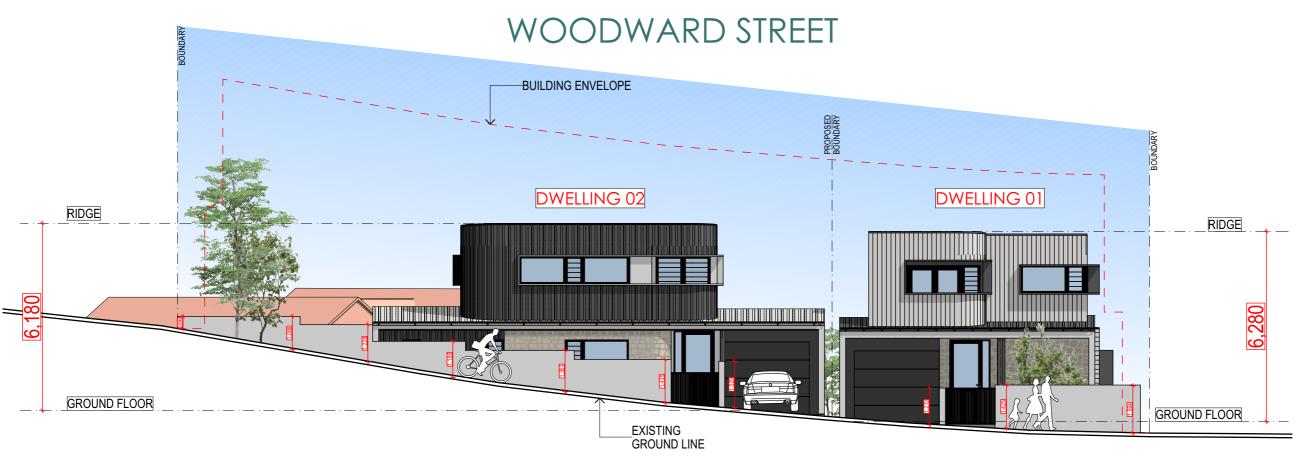

E-100	Street Elevation
1:125	

Woodward Street Dual Occupancy

26 Woodward Street Merewether 2291 Nicole & Stephen



Elevations - Street Drawing No.

DA-305


Scale As Shown @ A3

2168

Project Number

Description Council Submission Council RFI

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SECTION A-A

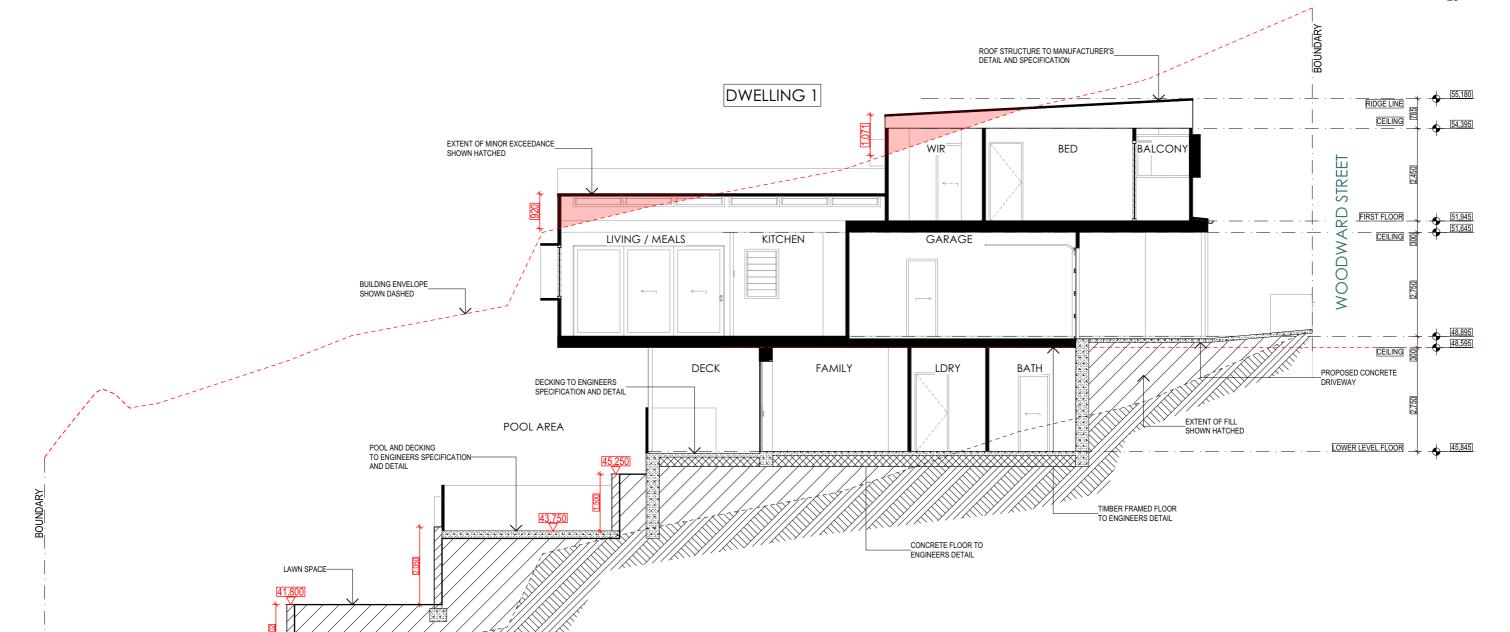PROPOSED GROUNDLINE

Woodward Street Dual Occupancy

26 Woodward Street Merewether 2291

Nicole & Stephen



Drawing Project Number Sections 2168

EXISTING GROUNDLINE SHOWN DASHED

Drawing No.

DA-400

Scale As Shown @ A3

Description Council Submission Council RFI

RELEVANT STANDARDS.

NEW BUILDING WORK.

SECTION NOTES:

OF PRACTICE.

WIND RATING.

4055

- ALL TIMBER BEAMS & POSTS EXPOSED TO OUTSIDE ELEMENTS ARE TO BE TREATED PINE OF APPROPRIATE

GRADE OR SUITABILITY OF TIMBER WITH A HIGH

- PRE-FABRICATED FRAME TO MANUFACTURERS

SPECIFICATION AND IN ACCORDANCE WITH AS 1684 (NATIONAL TIMBER FRAMING CODE), ALSO BRACED TO CORRECT WIND RATING IN ACCORDANCE WITH AS

(WIND LOADS FOR HOUSING). BUILDER TO DETERMINE

MOISTURE/WATER ARE CONCERNED INCLUDING ROOF/SHOWER/CONCRETE SLAB IN CONSTRUCTION OF THIS DWELLING ARE TO BE SUITABLY FLASHED AND

TREATED IN ACCORDANCE WITH AS 3740 AND

- ALL TREATMENT IN ACCORDANCE WITH AS 3660.1

- ALL BEAMS TO PITCHING POINTS e.g BULKHEADS TO FRAMING MANUFACTURERS SPECIFICATION.


- INSTALLATION OF WET AREA WATERPROOFING WHERE

RESISTANCE TO TERMITES, SEALED & FINISHED CORRECTLY. CHECK LOCAL AUTHORITIES STANDARD

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CONFIRM BUILDING DIMENSIONS PRIOR TO & DURING CONSTRUCTION

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В	SECTION B-B
1:100	

- ALL TIMBER BEAMS & POSTS EXPOSED TO OUTSIDE ELEMENTS ARE TO BE TREATED PINE OF APPROPRIATE GRADE OR SUITABILITY OF TIMBER WITH A HIGH RESISTANCE TO TERMITES, SEALED & FINISHED CORRECTLY. CHECK LOCAL AUTHORITIES STANDARD OF PRACTICE.

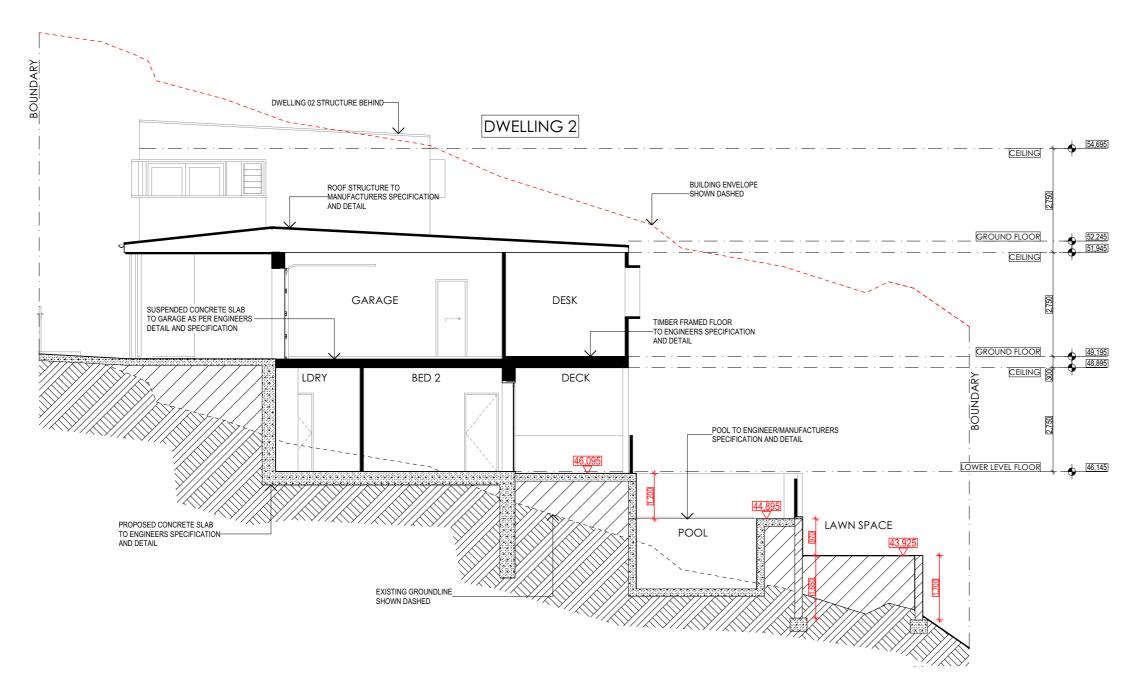- PRE-FABRICATED FRAME TO MANUFACTURERS SPECIFICATION AND IN ACCORDANCE WITH AS 1684 (NATIONAL TIMBER FRAMING CODE), ALSO BRACED TO CORRECT WIND RATING IN ACCORDANCE WITH AS 4055

(WIND LOADS FOR HOUSING). BUILDER TO DETERMINE WIND RATING.

- INSTALLATION OF WET AREA WATERPROOFING WHERE MOISTURE/WATER ARE CONCERNED INCLUDING ROOF/SHOWER/CONCRETE SLAB IN CONSTRUCTION OF THIS DWELLING ARE TO BE SUITABLY FLASHED AND TREATED IN ACCORDANCE WITH AS 3740 AND RELEVANT STANDARDS.

- ALL TREATMENT IN ACCORDANCE WITH AS 3660.1 NEW BUILDING WORK.
- ALL BEAMS TO PITCHING POINTS e.g BULKHEADS TO FRAMING MANUFACTURERS SPECIFICATION.

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Woodward Street Dual Occupancy

26 Woodward Street Merewether 2291


Nicole & Stephen



Drawing Sections	Project Number 2168	Revision A B	Description Council Submission Council RFI	Date 28.03.22 26.10.22
Drawing No.	Scale As Shown @ A3	FOR AUTH	ORITY APPROVAL ONLY (NOT I	FOR CONSTRUCTION)



0412 879 643

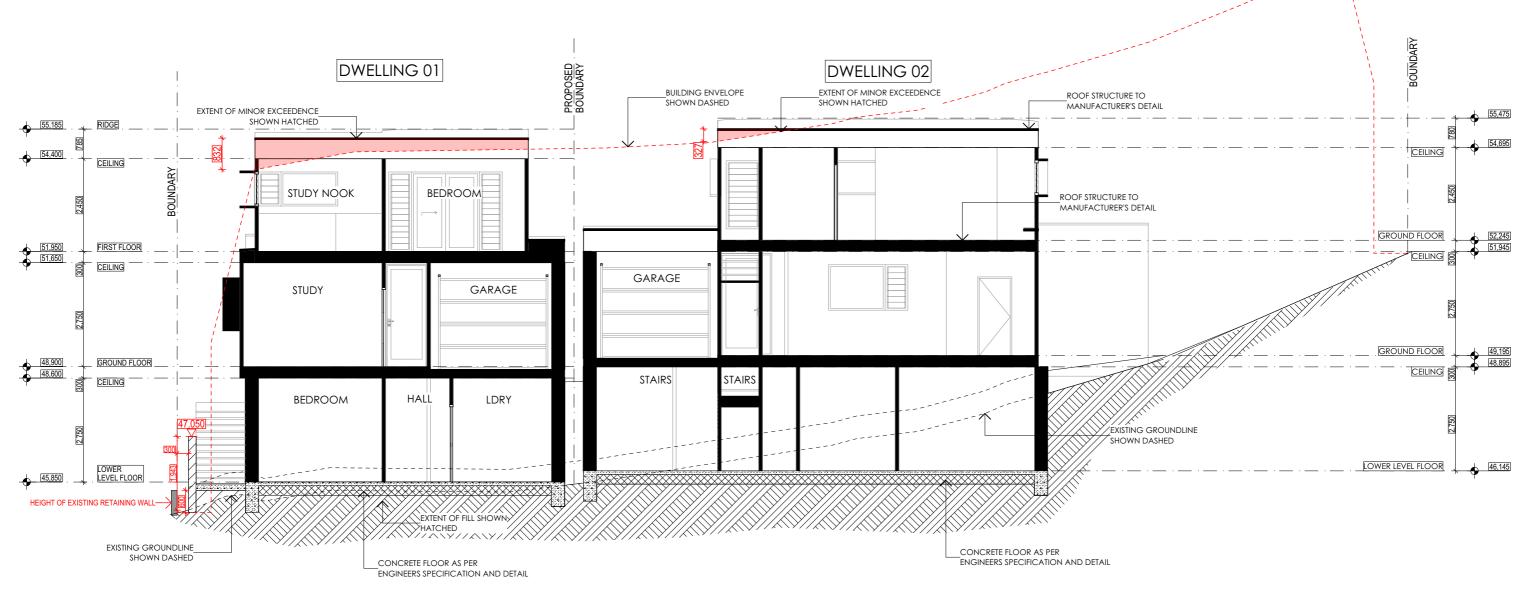

SECTION C-C

SECTION NOTES:

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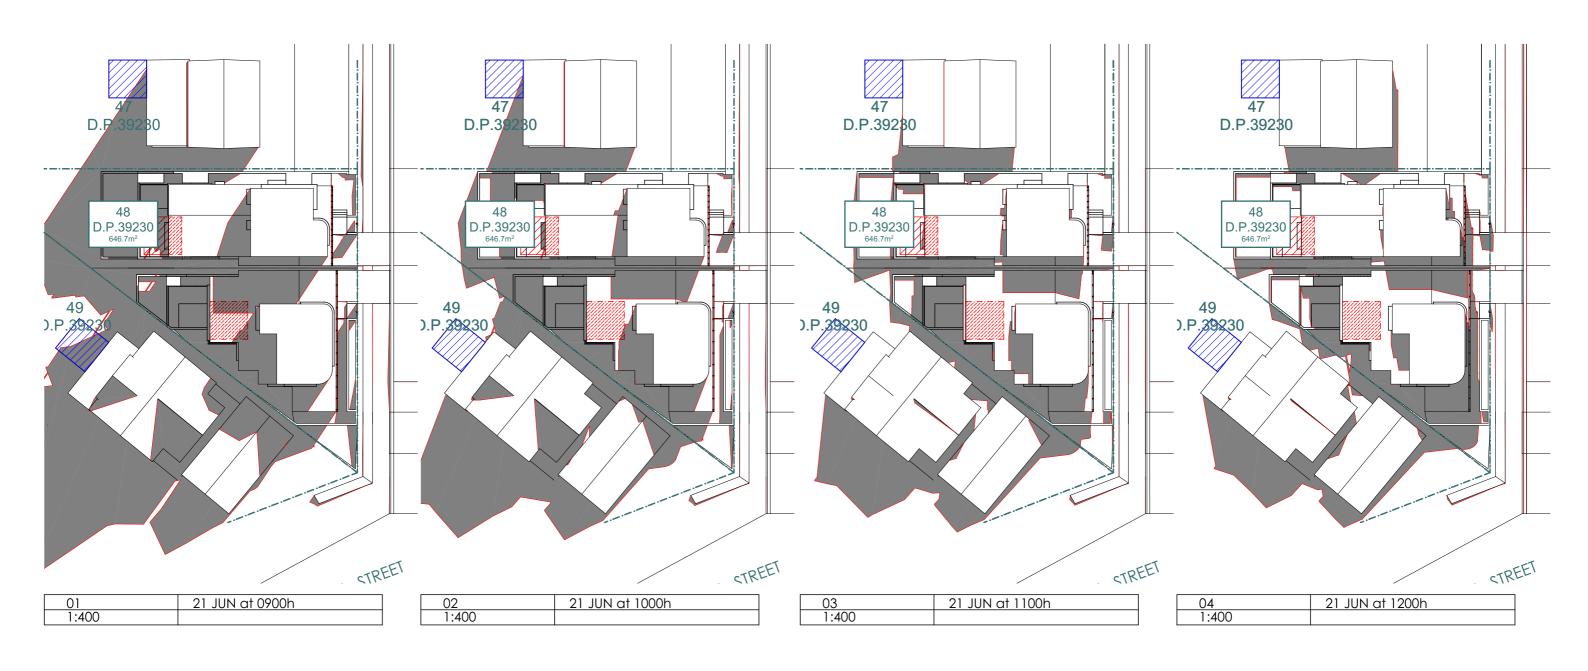
Woodward Street Dual Occupancy

26 Woodward Street Merewether 2291 Nicole & Stephen



Drawing Sections	Project Number 2168	Revision A B	Description Council Submission Council RFI	Date 28.03.22 26.10.22	S	hc
Drawing No. DA-402	Scale As Shown @ A3	FOR AUTH	ORITY APPROVAL ONLY (NOT FOR CO	NSTRUCTION)	e: m:	joel@shadedes 0412 879 643





26 Woodward Street Merewether 2291

Nicole & Stephen





Shadow Diagrams - JUN 21st

Drawing No. DA-500 Project Number 2168

Scale As Shown @ A3 Description Council Submission Council RFI

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26 Woodward Street Merewether 2291

Nicole & Stephen






Shadow Diagrams - JUN 21st

Drawing No. DA-501 Project Number 2168

Scale As Shown @ A3

Revision	Description	Date
A	Council Submission	28.03.22
3	Council RFI	26.10.22

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26 Woodward Street Merewether 2291

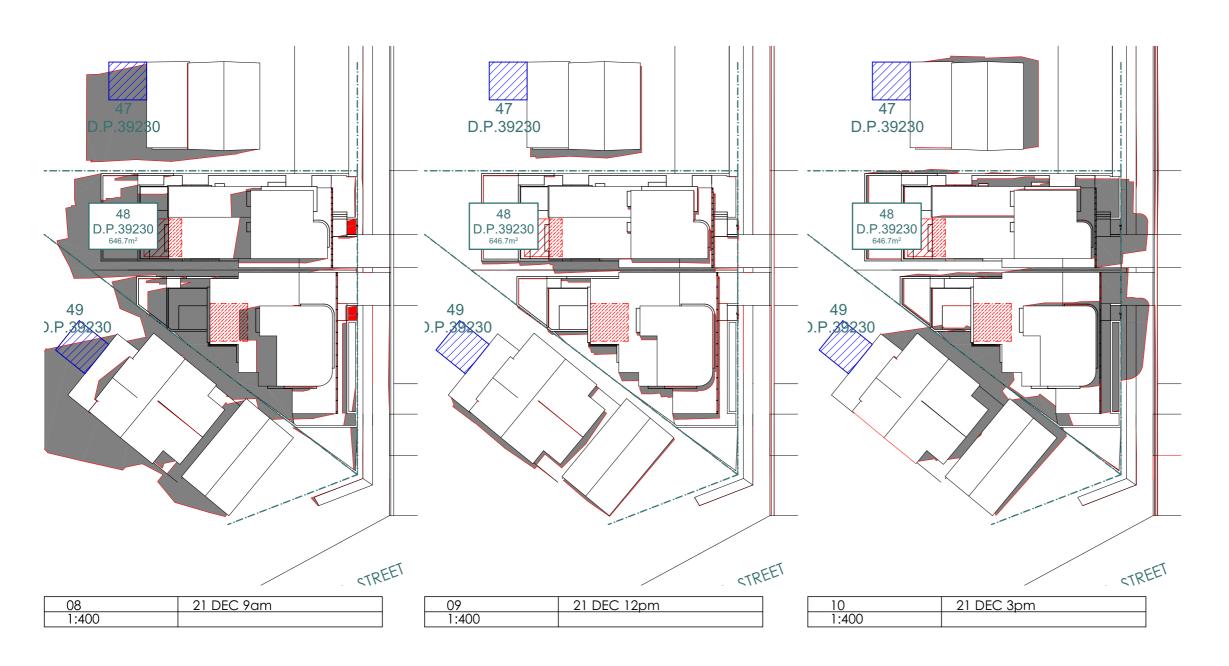Nicole & Stephen





Shadow Diagrams - DEC 21st


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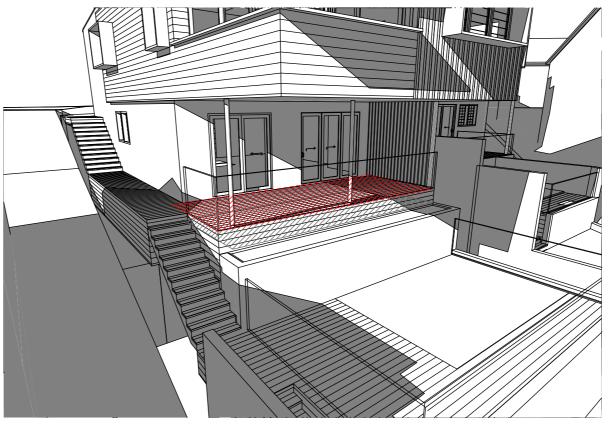
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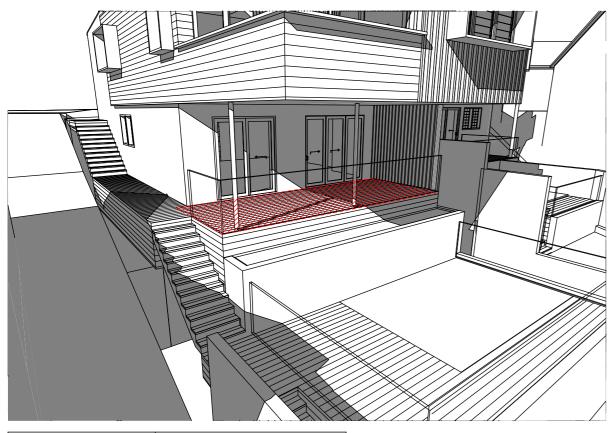
Description







21 JUN at 1000

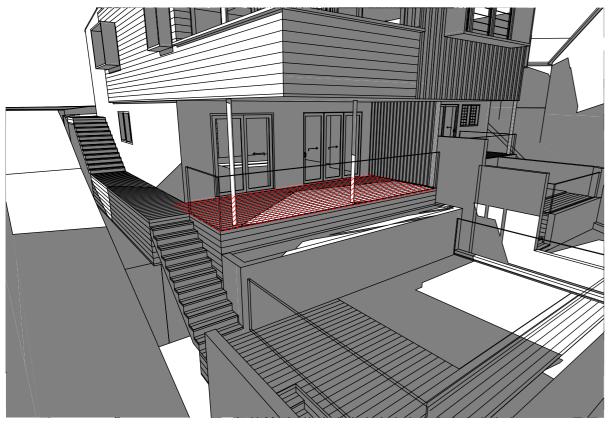

21 JUN at 1100

Woodward Street **Dual Occupancy**

26 Woodward Street Merewether 2291

Nicole & Stephen



14	21 JUN at 1200


Project Number Perspective Shadow Diagrams 2168


DA-503

Scale Drawing No. As Shown @ A3

Description Council Submission Council RFI

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21 JUN at 1300

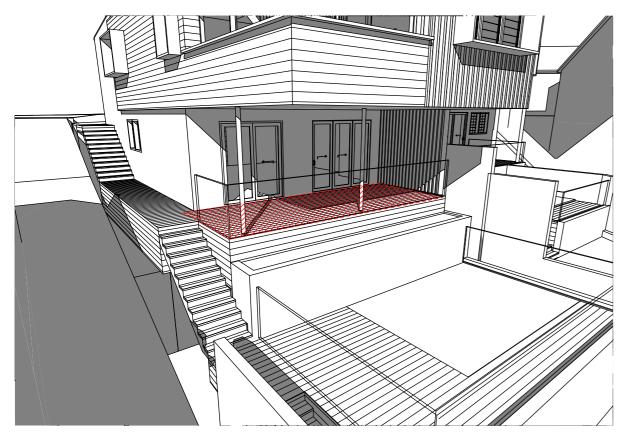21 JUN at 1500

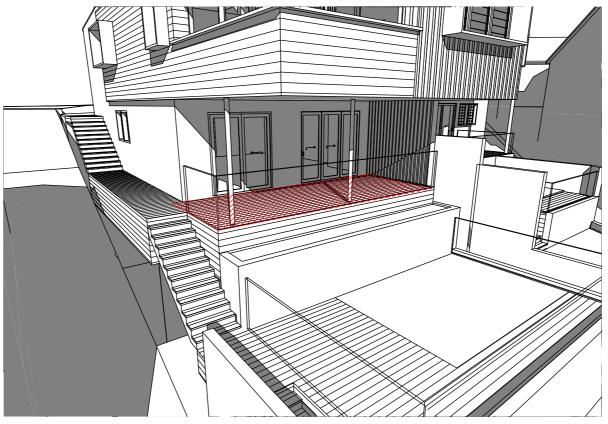Woodward Street **Dual Occupancy**

26 Woodward Street Merewether 2291

Nicole & Stephen




Perspective Shadow Diagrams


Drawing No. DA-504 **Project Number** 2168


Scale As Shown @ A3

Revision	Description
A	Council Submission
В	Council RFI

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Woodward Street **Dual Occupancy**

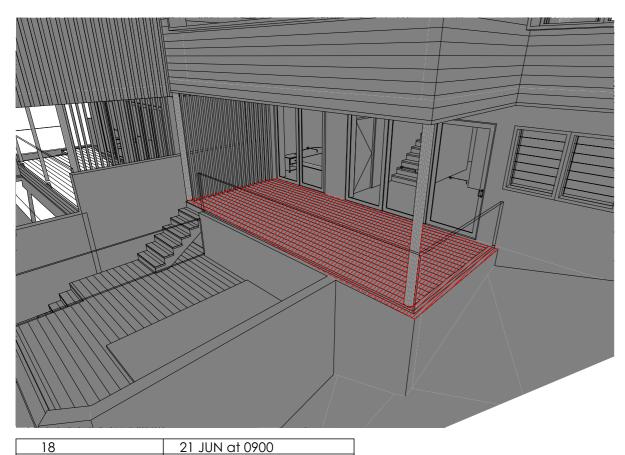26 Woodward Street Merewether 2291 Nicole & Stephen

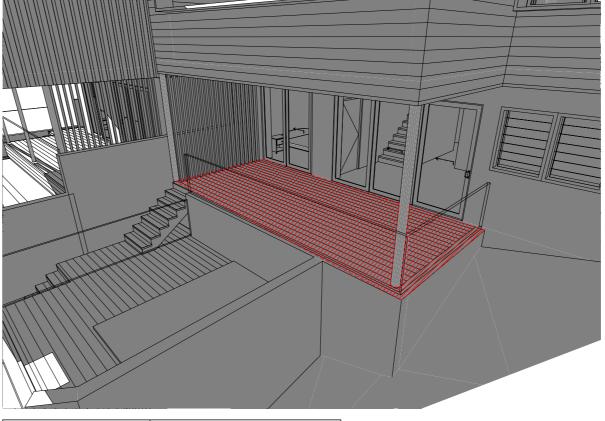

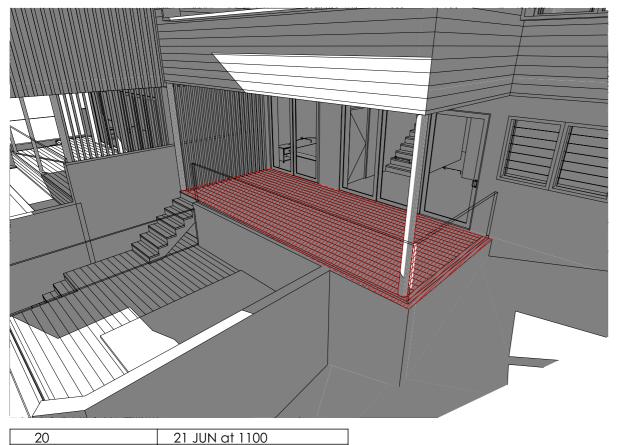Perspective Shadow Diagrams 2168

Drawing No.

DA-505

Project Number

As Shown @ A3


Scale


21 JUN at 1200


Council Submission Council RFI

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Woodward Street **Dual Occupancy**

26 Woodward Street Merewether 2291

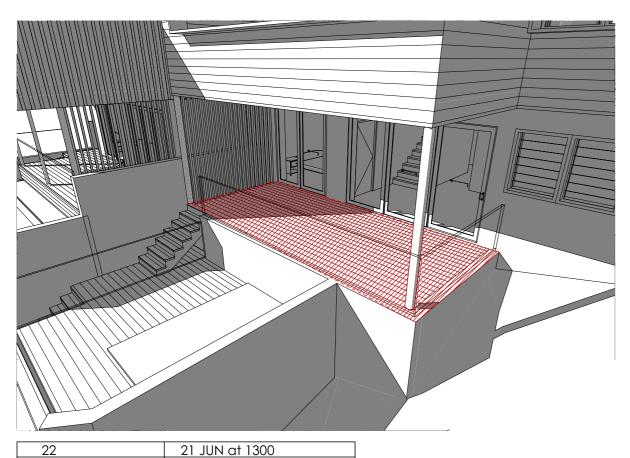Nicole & Stephen

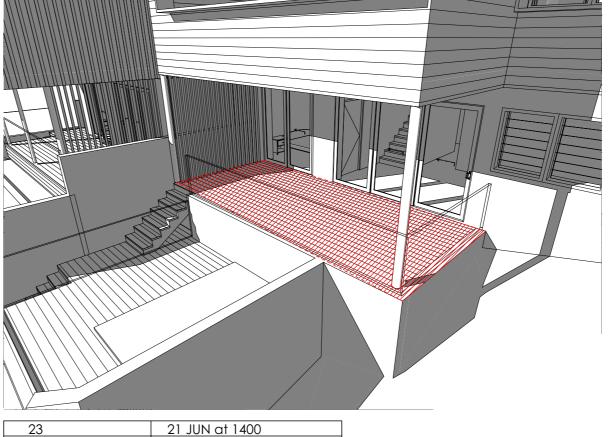

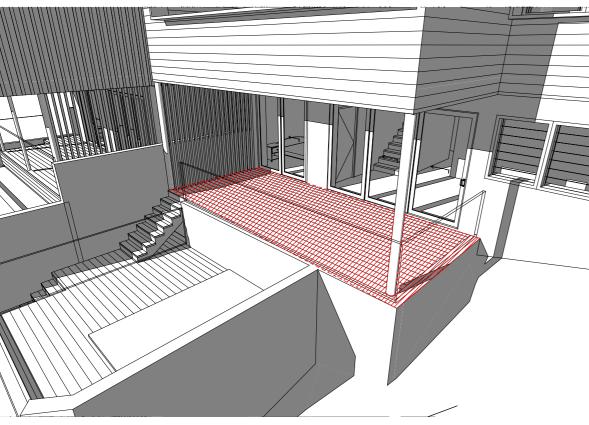Perspective Shadow Diagrams 2168

DA-506

Scale Drawing No. As Shown @ A3

Council Submission Council RFI

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e: joel@shadede
m: 0412 879 643

BASIX Notes

DMN Assessor #16/1742 28th March 2022 Reference: 113/2022

Evergreen Energy Consultants

Email address: enquiries@evergreenec.com.au Ph: 1300 584 010

Important Note for Development Applicants:

The following specification was used to achieve the thermal performance values indicated on the Assessor Certificate. If they vary from drawings or other specifications this Specification shall take precedence. If only one specification option is detailed for a building element, that specification must apply to all instances of that element for the whole project. If alternate specifications are detailed, the location and extent of the alternate specification must be detailed below and / or clearly indicated on referenced documentation.

Once the development is approved by the consent authority, these specifications will become a condition of consent and must be included in the built works. If you do not want to include these requirements, the proposed construction varies to those detailed or need further information, please contact Evergreen Energy Consultants.

This assessment has assumed that the BCA provisions for building sealing will be complied with at construction

External Wall Brick	CONSTRUCTION	Insulation			
Brick	1.1		,	Absorbance)	Detail
	Veneer	Anti-glare foil with bulk no gap R2.5	Lig	ght	
Fibro Cavity Panel Direct Fix		Anti-glare foil with bulk no	Light a	nd Dark	
Tible cavity Faller Bilect Fix		gap R2.5	Light a	na Dank	
Concrete Block (Retaining		Anti-glare foil with bulk no	Lig	ght	
walls)		gap R2.5			
230m	nm Brick	None	Med	dium	Garage Walls
Internal Wall Construction		Insulation		Detail	
Cavity wa	all, direct fix	None			
plasterboard					
	all, direct fix	Bulk insulation R2.5	Internal	walls adjoining	garages
plasterboard		1 1 "		D / "	
Ceiling Co		Insulation		Detail	
Plasterboar	rd with Timber	Bulk insulation R4.0	E	External ceiling	S
Timber above Plasterboard		None	Internal ceilings		S
Timber above Plasterboard		Bulk insulation R1.0	Garage ceilings		S
Roof Construction		Insulation	Colour (Solar Absorptance)		Detail
Cold	orbond	Bulk, reflective side down, no air gap above R1.3		Unit 1 Unit 2	3°, 6° an 12° pitol
Floor Co	nstruction	Insulation	Ligiti	Covering	12 pito
Concrete Slab on Ground		None	Carpet, Timber and Tiles		
	ed Concrete	Bulk insulation in contact	Timber		
Suspende	ed Concrete	with floor R1.0		HIIIDEI	
Suspend	ded Timber	Bulk insulation in contact	Carpet		
		with floor R1.0			
Windows	Glass and frame t	ype	U Value	SHGC	Area m2
	luminium framed 38CP Fixed Windo	ows Single Glazed	3.92	0.48	
	uminium framed	lows Single Glazed	4.47	0.50	
	uminium framed				
63	38CP Sliding Door	s Single Glazed	4.42	0.44	
	luminium framed 38CP Hinged Doo	rs Single Glazed	4.62	0.39	
GJA-090-34 A AI	luminium framed B8CP Bi-Folds Sin		4.48	0.40	
J and SHGC val	lues are according	g to NFRC. Alternate products wer than the above figures.		the U value is	lower and th

Nominal only, refer to plan for detail

Verandah to certain units only

Shaded areas and shade devices as drawn, adjoining buildings and boundary fences

- Thermal construction in accordance with Vol 1 Section J1.2 or Vol 2 Part 3.12.1.1

- Building sealing in accordance with Section J3 or Part 3.12.3.1 to 3.12.3.6.

For construction in NSW the BCA Vol 1 or 2 must be complied with, in particular the following:

- Thermal breaks in accordance with Section J1.3(d) & 1.5(c) or Part 3.12.1.2(c) & 3.12.1.4(b)

- Compensating for loss of ceiling insulation in accordance with Section J1.3(c) or Part 3.12.1.2(e) - Floor insulation in accordance with Section J1.6(c) & (d) or Part 3.12.1.5(a)(iii) or (c) & (d)

Pools Not more than 27 & 12kL Outdoors Solar Heating Only **Pool Pump Timer** Fixtures 3 Star Shower Heads 3 Star Toilet 3 Star Kitchen Taps 3 Star Basin Taps THERMAL COMFORT COMMITMENTS – Refer to TPA Specification on plans **ENERGY COMMITMENTS** Hot Water Gas instantaneous 6 star Cooling Living 1-phase air conditioning EER 2.5-3.0 (zoned) System **Bedrooms** 1-phase air conditioning EER 2.5-3.0 (zoned) Heating Living 1-phase air conditioning EER 2.5-3.0 (zoned) **Bedrooms** 1-phase air conditioning EER 2.5-3.0 (zoned) System Ventilation **Bathrooms** Fan ducted to roof/facade Manual on/off Kitchen Fan ducted to roof/facade Manual on/off Laundry Fan ducted to roof/facade Manual on/off

Window/Skylight in Kitchen

Number of Living/Dining rooms

Number of bedrooms

All Bathrooms/Toilets

Yes

Gas cooktop, gas oven

Kitchen

Laundry

All Hallways

Window/Skylight in Bathrooms/Toilets

Alternative Water - Rainwater Tank Size 4,000(L) Tank/Unit Connected To:

WATER COMMITMENTS

Fixtures

All Toilets

Natural

Lighting

Artificial

Lighting

(Primarily lit

by fluoro or

LED)

Stove/Oven

Other

OTHER COMMITMENTS
Outdoor clothes line

26 Woodward Street, Merewether

SUMMARY OF BASIX COMMITMENTS

This is a summary of the BASIX Commitments as detailed in the BASIX Certificate.

Refer to the CURRENT BASIX Certificate for Complete details.

One Outdoor Tap | Laundry W/M Cold Tap | Tap within 10m of Pools

As Drawn

As Drawn

Dedicated

Dedicated

Dedicated

Dedicated

Dedicated

Dedicated

Indoor or sheltered clothes drying line No

Yes

Yes

Yes

Yes

Yes

Yes



ΑII

Αll

Yes

Yes

Yes

Yes

Photovoltaic system to generate 1.8 peak kW of electricity – Unit 1 only Ceiling fans to be installed – Refer to NatHERS certificate for locations

Woodward Street Dual Occupancy

As drawn

Fixed shading - Other

26 Woodward Street Merewether 2291 Client

Nicole & Stephen



Drawing Project Number Revision Description Date BASIX 2168 A Council Submission Council RFI 28.03.22 26.10.22 Drawing No. Scale DA-700 As Shown @ A3 FOR AUTHORITY APPROVAL ONLY (NOT FOR CONSTRUCTION) FOR AUTHORITY APPROVAL ONLY (NOT FOR CONSTRUCTION) m: 0412 879 643

NOTES:

BUILDER TO CONFIRM WITH SELECTED
WINDOW/DOOR MANUFACTURER ALL
WINDOW/DOOR DIMENSIONS, OPENING
DIRECTIONS & HINGE LOCATIONS
- PLEASE REFER TO CURRENT BASIX REPORT FOR
ENERGY PERFORMANCE REQUIREMENTS &
SPECIFICATIONS
- BUILDER TO CONFIRM LEVELS AND DIMENSIONS
PRIOR TO AND DURING CONSTRUCTION. ANY
DISCREPENCIES ARE TO BE REPORTED TO THE
BUILDING DESIGNER BEFORE CONSTRUCTION.
- USE FIGURED DIMENSIONS ONLY. DO NOT SCALE
FROM DRAWINGS

shade

The inform

Area Schedule (m2)

Dwelling 01	
01. GFA	180
02. Garage	20
Dwelling 02	
01. GFA	191
02. Garage	20
Site Calculations	
01. Landscaping	263
Proposed Lot 1	341
Proposed Lot 2	304
Total Areas	
01. Dwelling 01	228
02. Dwelling 02	240

NOTE:

AREAS SHOWN ARE APPROXIMATES ONLY AND SPECIFICALLY INTENDED FOR THE CALCULATION PURPOSES IN SUPPORT OF A DEVELOPMENT APPLIACTION. TOTAL CONSTRUCTION AREAS CAN BE PROVIDED AT THE REQUEST OF THE CLIENT OR BUILDER AND ARE TO BE CONFIRMED AGAIN AT THE CONSTRCUTION CERTIFICATE STAGE.

NOT CONSTRUCTION AREAS

Woodward Street Dual Occupancy

26 Woodward Street Merewether 2291

Nicole & Stephen



Area Schedules Drawing No.

DA-800

Project Number 2168

Scale As Shown @ A3 Description Council Submission Council RFI

FOR AUTHORITY APPROVAL ONLY (NOT FOR CONSTRUCTION) m: 0412 879 643

Sediment and erosion control

All erosion and sediment control measures to be installed prior to site disturbance.

The project manager to inform all contractors and sub-contractors of their obligations under the erosion and sediment control plan.

Topsoil from all areas that will be disturbed to be stripped and stockpiled at the nominated site.

All sediment control structures to be inspected by site supervisor after each rainfall event for structural damage and all trapped sediment to be removed to a nominated stockpile site.

Sediment and erosion control shall be effectively maintained at all times during the course of construction and shall not be removed until the site has been stabilised or landscaped to the superintendent's satisfaction.

A single all weather access way will be provided at the front of the property consisting of 50-75 aggregate or similar material at a minimum thickness of 150 laid over needle-punched geotextile fabric and constructed prior to commencement of works.

The contractor shall ensure that no spoil or fill encroaches upon adjacent areas for the duration of works.

The contractor shall ensure that kerb inlets and drains receiving stormwater shall be protected at all times during development. Kerb inlet sediment traps shall be installed along the immediate vicinity along the street frontage.

Sediment fencing shall be secured by post (where metal star pickets are used plastic safety caps shall be used) at 3000 intervals with geotextile fabric embedded 200 in soil.

All topsoil stripped from the site and stockpiled does not interfere with drainage lines and stormwater inlets and will be suitably covered with an impervious membrane material and screened by sediment fencing.

Soil conservation

Prior to commencement of construction provide 'sediment fence,' 'sediment trap' and washout area to ensure the capture of water borne material generated from the site.


Maintain the above during the course of construction, and clear the 'sediment trap after each storm.


Sediment trap

1000 x 1000 wide 500 deep pit, located at the lowest point to the trap sediment.

Sediment fence

Provide sediment fence on down slope boundary as shown on plan. Fabric to be buried below ground at lower edge.

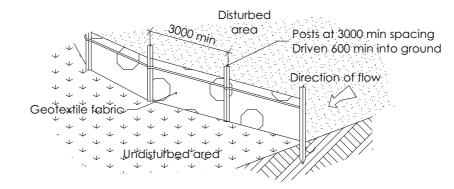


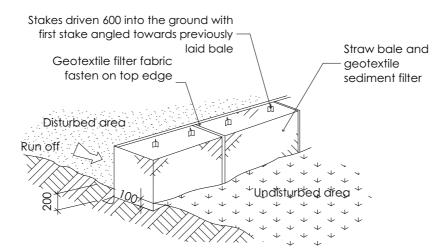

Drainage area 0.5 ha. max. slope gradient 1:2 max. slope length 50m.


Washout area

to be 1800 x 1800 allocated for the washing of tool and equipment

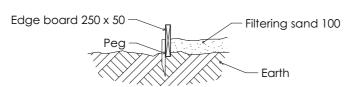


Vehicle access to site

Vehicle access to the building site should be restricted to a single point so as to reduce the amount of soil deposited on the street pavement.

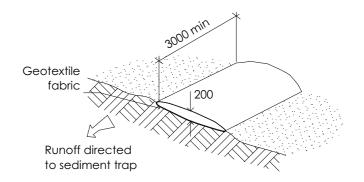


Building material stockpiles

All stockpiles of building material such as sand and soil must be protected to prevent scour and erosion, they should never be placed in the street gutter where they will wash away with the first rainstorm.

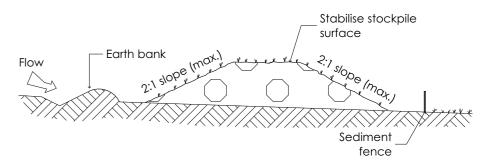

Sandbag kerb sediment trap

In certain circumstances extra sediment trapping may be needed in the street gutter.

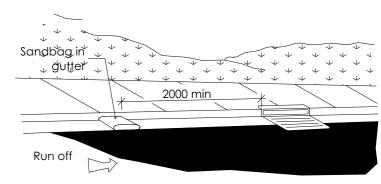

Woodward Street Dual Occupancy

26 Woodward Street Merewether 2291


Nicole & Stephen







with duvice to be sought into it in exappropriate centifying authorities by the land owner/holder. Verify all dimensions prior to & during construction, use figured dimensions only do not scale from drawings. Shade Design Newcastle Pty Ltd cannot guarantee the accuracy of content and format for copies of drawings issued electronically. This document shall not be used for construction unless endorsed 'For Construction' and authorised for issue.

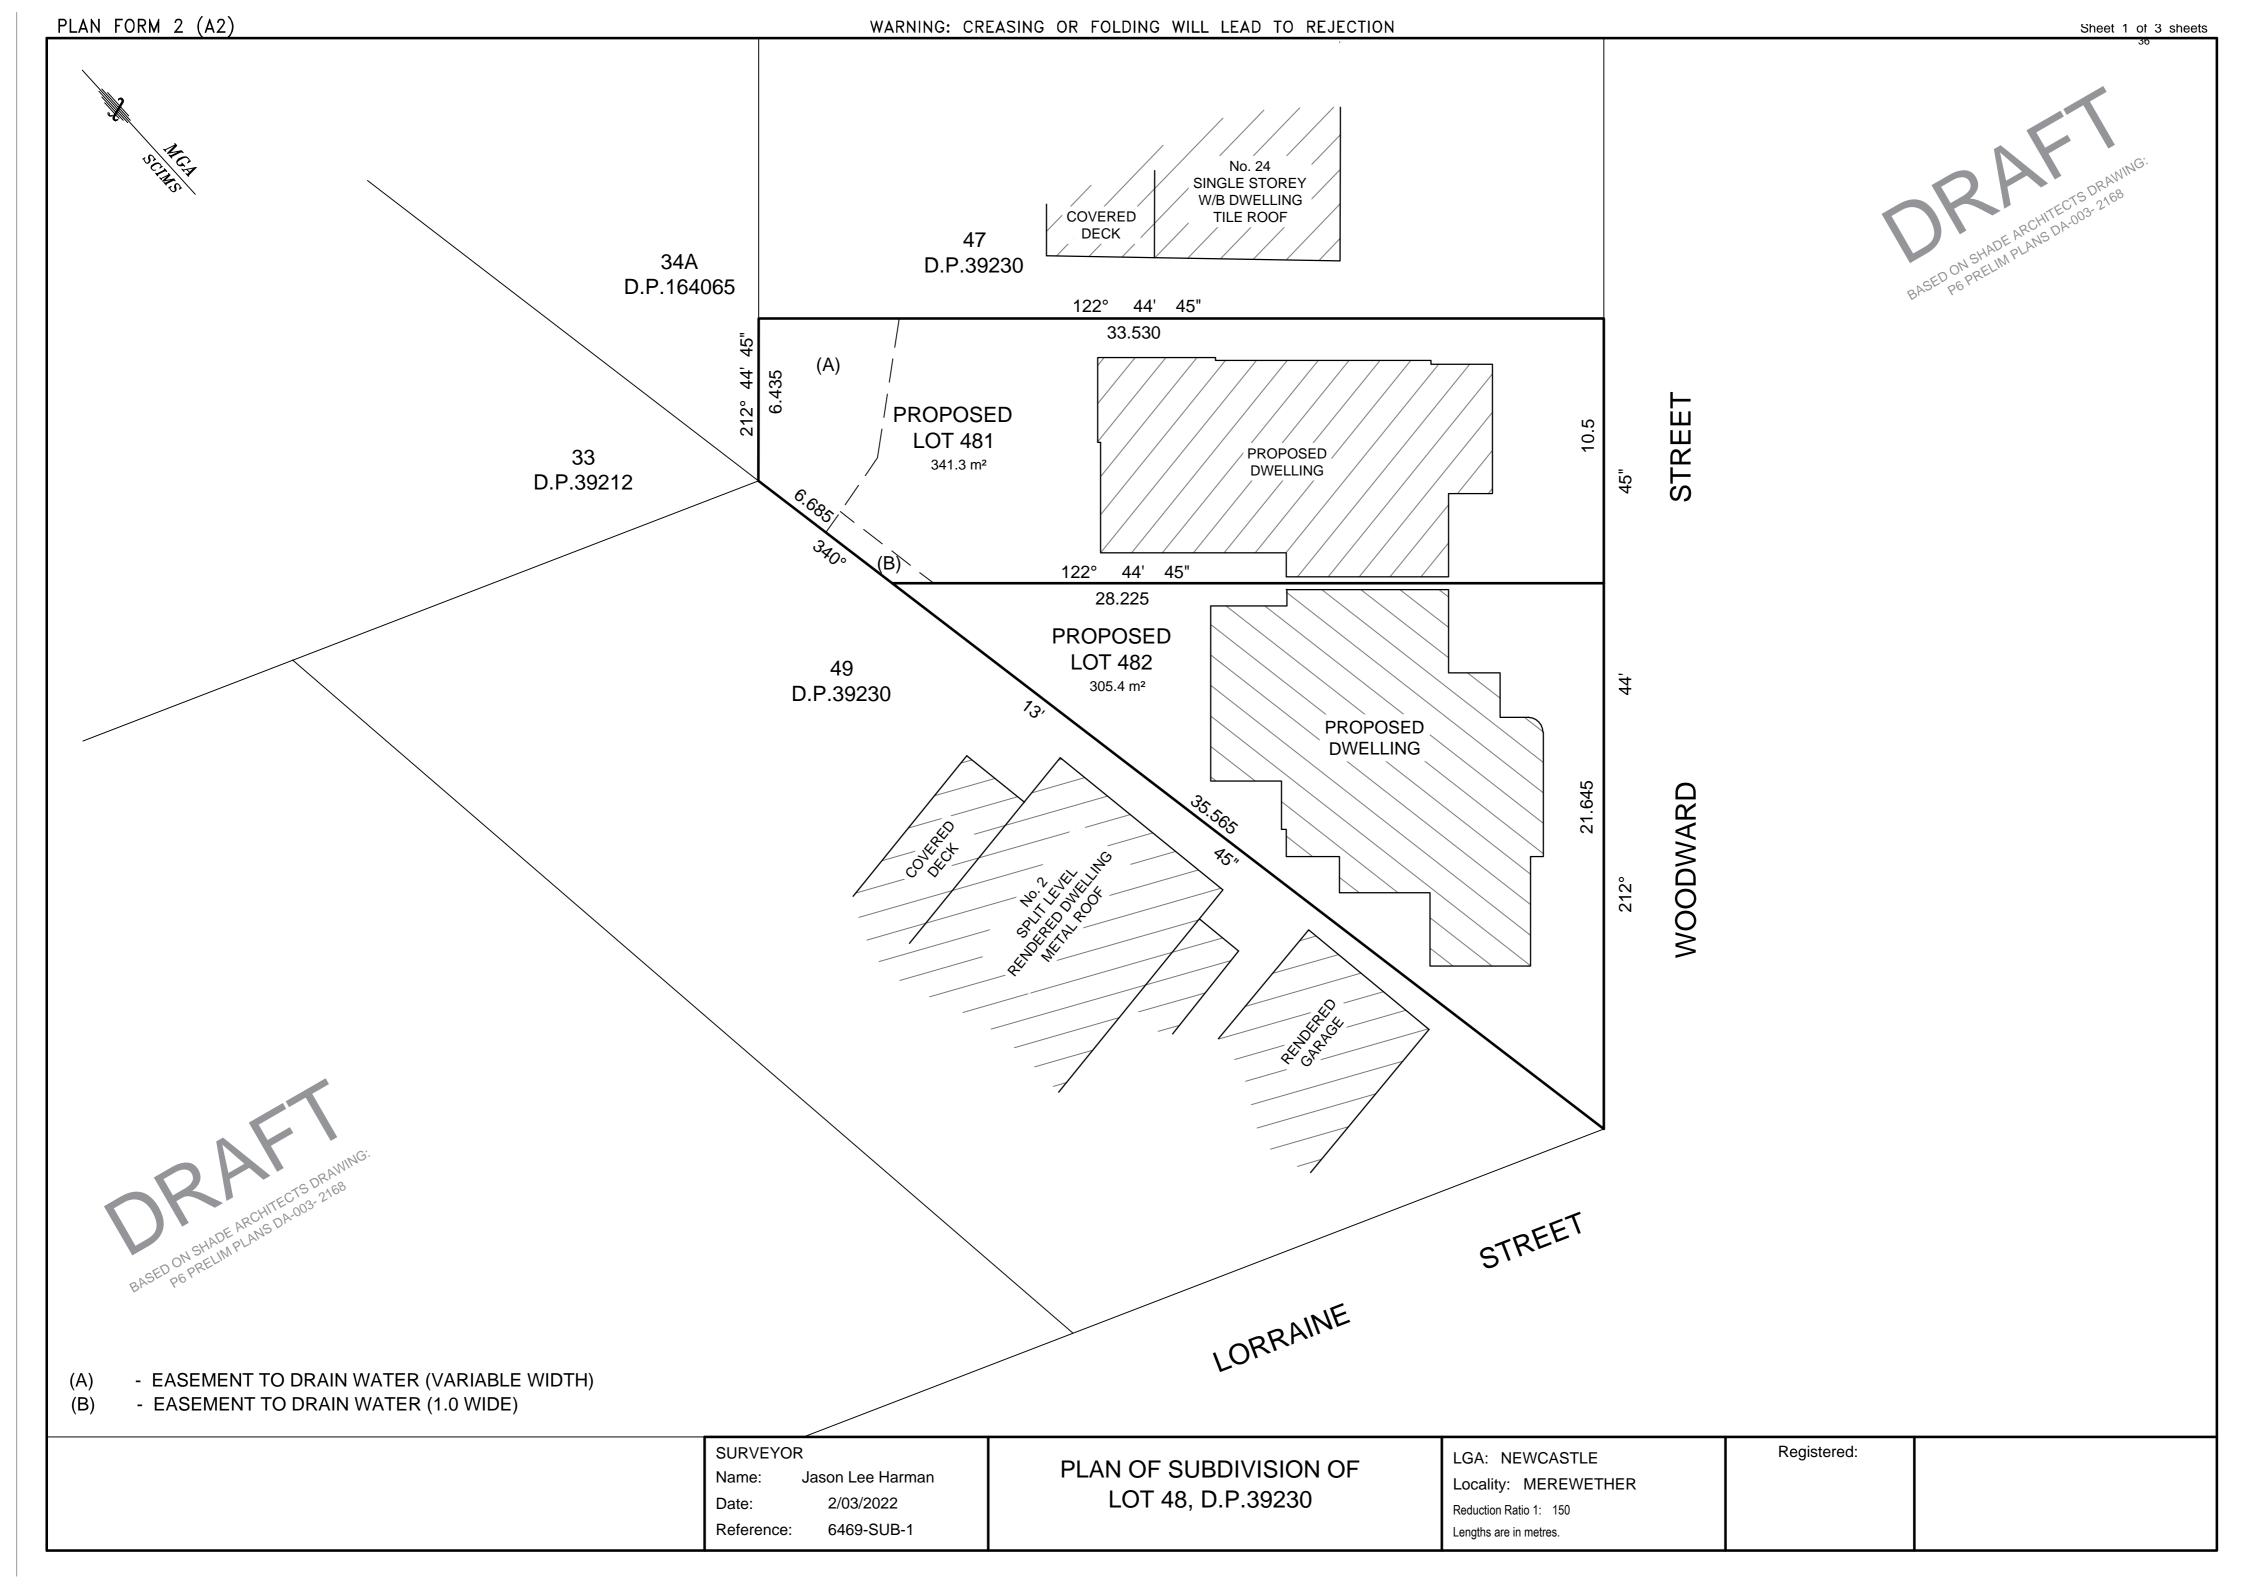

PLAN FORM 6 (2017)	DEPOSITED PLAN ADMINISTRATION SHEET		Sheet 2 of 3 sheet(s)	
	Office Use Only		Office Use Only	
Registered:				
Title System:			RLAND	
PLAN OF SUBDIVISIO	N OF	LGA: NE VC STLI	TECTS DRA'8	
LOT 48 D.P. 39230		Locality: MLRV ETHER	RCHITE DA-003	
		Parish: MEWCASTLE?	LAM	
		County: NORTHUMBER	RLAND	
Survey JASON LEE HARMAN	Certificate	Crown Lands NSW/Weste	rn Lands Office Approval	
LAND DEVELORMEN	TO SOLUTIONS PTY LTD	1	` /	
P.O. BOX 853 THE JI a surveyor registered under the Su		approving this plan certify that all ne allocation of the land shown herein l		
2002, certify that:	12 1 20 0	Signature:		
*(a) The land shown in the plan w Surveying and Spatial Informa	ation Regulation 2017, is accurate	Date:		
and the survey was completed	onXXth XXXXXX 20XX, or	File Number:		
*(b) The part of the land shown in	the plan (*being/*excluding **	Office:		
was surveyed in accordance v		011106.		
	the part surveyed is accurate and the the part not surveyed	Subdivision	Certificate	
was compiled in accordance v		I,		
*(c) The land shown in this plan was compiled in accordance with the ——Surveying and Spatial Information Regulation 2017.		*Authorised Person/*General Manage the provisions of section 6.15 <i>Environ</i> <i>Act</i> 1979 have been satisfied in relations.	nmental Planning and Assessment	
Datum Line:X - Y		new road or reserve set out herein.	, , , , , , , , , , , , , , , , , , , ,	
Type: *Urban/ *Rural		Signature:		
The terrain is *Level-Undulating /-	*Steep-Mountainous.	Accreditation number:		
Signature:	Dated: XX/XX/2022	Consent Authority: Date of endorsement:		
Surveyor Identification No:422	1	Subdivision Certificate number:		
Surveyor registered under the Surveying and Spatial Informa	ation Act 2002	File number:		
* Strike through if inapplicable.		The number		
**Specify the land actually surveyed or specify any land shown in the plan that is not the subject of the survey.		*Strike through if inapplicable.		
Plans used in the preparation of s	urvey /compilation.	Statements of intention to dedicate	•	
D.P. XXXXXX D.P. XXXXXX		and drainage reserves, acquire/resul	me land.	
D.P. XXXXXX				
Surveyor's Reference: 6469	-SUB-1	Signatures, Seals and Section 86		

PLAN FORM 6A (2017)	DEPOSITED PLAN AD	Sheet	3 of	3	sheet(s)	
	Office Use Only			Offic	e l	Jse Only
Registered:						
PLAN OF SUBDIVISION LOT 48 D.P. 39230	N OF					
		 This sheet is for the provision of the fol A schedule of lots and addresses Statements of intention to create accordance with section 88B Con 	s - See 60(c) and release	SSI R affect	egul ing ir	ation 2017
		 Signatures and seals- see 195D C Any information which cannot fit in 1 of the administration sheets. 	Conveyancin	g Act	1919	
(A)		DT! I)				

- (A) EASEMENT TO DRAIN WATER (VARIABLE WIDTH)
- (B) EASEMENT TO DRAIN WATER (1.0 WIDE)

STREET ADDRESS SCHEDULE

LOT	STREET NUMBL R	STREET NAME	STREET TYPE	LOCALITY
1	26A	WOODWARD	STREET	MEREWETHER
2	26B BAS	₩OODWARD	STREET	MEREWETHER

Surveyor's Reference: 6469-SUB-1

ATTACHMENTS DISTRIBUTED UNDER SEPARATE COVER

DAC 06/12/22 – 26 WOODWARD STREET MEREWETHER – DA2022/00382 AND DUAL OCCUPANCY – INCLUDES DEMOLITION AND SUBDIVISION (2 LOTS) TORRENS TITLE

ITEM-25 Attachment B: Draft Schedule of Conditions

DRAFT SCHEDULE OF CONDITIONS



Application No: DA2022/00382

Land: Lot 48 DP 39230

Property Address: 26 Woodward Street Merewether NSW 2291

Proposed Development: Demolition and Construction of Dual Occupancy 2 x three-

storey dwellings and Subdivision – Torrens Title (2 lots)

SCHEDULE 1

Approved Documentation

 The development is to be implemented in accordance with the plans and supporting documents set out in the following table except where modified by any conditions of this consent.

Plan No / Supporting	Reference /	Prepared by	Dated
Document	Version		
Architectural Plans Cover	Project No.2168,	Shade Design	26/10/2022
Page & Plan Set	Rev B	Newcastle	
Stormwater Drainage	Job No.6469,	Land Development	10/03/2022
Plan	Edition A, Dwg No.1	Solutions	
Subdivision Plan	Ref: 6469-SUB-1	Jason Harman	2/03/2022
Waste Management Plan	-	Shade Design	Undated
		Newcastle	
BASIX Certificate	Certificate	Evergreen Energy	28 March 2022
	No.1291305M	Consultants Pty Ltd	
NatHERs Certificates		Evergreen Energy	28 March 2002
No.0007170202		Consultants Pty Ltd	
No. 0007170228			
No. 0007170250			

In the event of any inconsistency between conditions of this development consent and the plans/supporting documents referred to above, the conditions of this development consent prevail.

CONDITIONS TO BE SATISFIED PRIOR TO THE ISSUE OF A CONSTRUCTION CERTIFICATE

2. In accordance with the City of Newcastle Section 7.11 Development Contributions Plan 2021-2036 (the Plan), the following monetary contributions shall be paid to the City of Newcastle to cater for the increased demand for transport and social infrastructure resulting from the development:

Description	Contribution (\$)
Transport	\$3,079.30
Open Space and Recreation	\$13,232.41

Community Facilities	\$2,447.89
Plan Preparation and Administration	\$468.31
TOTAL	\$19,227.91

If the contributions are not paid within the financial quarter that this consent is granted, the contributions payable will be adjusted in accordance with the provisions of the Plan and the amount payable will be calculated on the basis of the contribution rates applicable at the time of payment

The contributions shall be paid to the City of Newcastle:

- (i) prior to the issue of the Subdivision Certificate where the development is for subdivision; or
- (ii) prior to the issue of the first Construction Certificate where the development is for building work; or
- (iii) prior to issue of the Subdivision Certificate or first Construction Certificate, whichever occurs first, where the development involves both subdivision and building work; or
- (iv) prior to the works commencing where the development does not require a Construction Certificate or Subdivision Certificate.
- 3. Roof water from the proposed new work is to be directed to the proposed water tank with a minimum capacity of 4,000 litres per dwelling and being reticulated to any new toilet cisterns and cold-water washing machine taps, with a mains water top up being installed to maintain between 10% and 15% of the tank capacity. Alternatively, an electronically activated mechanical valve device is to be installed to switch any new toilet cisterns and laundry taps to mains water when the tank falls below 10% capacity. The water tank and plumbing is to be designed in accordance with the Plumbing Code of Australia (National Construction Code Volume 3). Full details are to be included in documentation for a Construction Certificate application.
- 4. Overflows from the roof water tank and any additional discharge controls (if required) are to be directed to Newcastle City Council's drainage system by means of an interallotment drainage line or underground pipe directly to the street gutter. Details are to be included in documentation for a Construction Certificate application.
- 5. All stormwater runoff from the proposed development is to be managed in accordance with the requirements of Element 7.06 'Stormwater' of Newcastle Development Control Plan 2012, the associated Technical Manual and AS/NZS 3500.3 Plumbing and drainage Part 3 Stormwater drainage, as indicated on the stormwater drainage plan prepared by Land Development Solutions (Job No.6469 Drg. No. 1, Edition A, dated 10/03/2022). Details are to be included in documentation for a Construction Certificate application.
- 6. All proposed courtyard, garden and lawn areas indicated on the submitted plan or otherwise required under the conditions of this consent, are to be comprehensively landscaped in accordance with the provisions of Newcastle Development Control Plan 2012. The required landscape works are to incorporate a minimum of one taller growing tree specimen in respect of each dwelling, such to be nominated on plans submitted with a Construction Certificate application.
- 7. Fences are to be constructed of sufficient height to afford privacy to residents in accordance with the performance criteria and provisions of Newcastle Development Control Plan 2012. Full details are to be included in the documentation for a Construction Certificate application.
- 8. The applicant is to comply with all of Hunter Water's requirements to provide your development with water supply and sewerage services. A copy of Hunter Water's compliance certificate (*Hunter Water Act 1991* Section 50) must be submitted with your

Construction Certificate application.

- 9. Facilities are to be provided within the proposed individual private courtyards, or in another screened location, for the storage of garbage. Full details are to be included in documentation for a Construction Certificate application.
- 10. The construction or erection of swimming pool safety fences and gates and all associated work is to be carried out in accordance with the *Swimming Pools Act 1992* and Regulations. Full details are to be included in the documentation for a Construction Certificate application.
- 11. The swimming pool/spa water recirculation and filtration system installation is to comply with *Australian Standard* 1926.3:2010 Swimming pool safety Water recirculation systems. Full details are to be included in the documentation for a Construction Certificate application.
- 12. Erosion and sediment control measures are to be implemented prior to the commencement of works and be maintained during the period of construction in accordance with the details set out on an Erosion and Sediment Control Plan that is to be submitted for approval with the Construction Certificate application. Controls are not to be removed until the site is stable with all bare areas supporting an established vegetative cover.
- 13. Prior to application for a Construction Certificate, working drawings and specifications of the proposed buildings are to be submitted to Subsidence Advisory NSW for approval and any requirements of Subsidence Advisory NSW are to be included in the documentation for a Construction Certificate application.

Note: Subsidence Advisory NSW have granted their approval of the development subject to conditions, dated 30 March 2022 and this accompanied lodgement of the subject development application.

- 14. A residential vehicular crossing is to be constructed across the road reserve, in accordance with the following criteria:
 - a) Constructed in accordance with City of Newcastle's A1300 Driveway Crossings Standard Design Details.
 - b) The driveway crossings, within the road reserve, is to be a maximum of 3m wide.
 - c) Letterboxes, landscaping and any other obstructions to visibility are to be kept clear of or limited in height to 1.2m, in the 2.0m by 2.5m splay within the property boundary, each side of the driveway entrance.
 - d) The proposed driveway is to be a minimum of 3.0m clear of the trunk of any tree within the road reserve.
 - e) The proposed driveway is to be a minimum of 750mm clear of the centre of any pole or obstruction within the road reserve and 1.0m clear of any drainage pit.

These works are not approved until consent under Section 138 of the *Roads Act 1993* has been granted by the City of Newcastle.

15. A separate application is to be lodged and consent obtained from Newcastle City Council for all works within the road reserve pursuant to Section 138 of the *Roads Act 1993*. The consent is to be obtained, or other satisfactory arrangements confirmed in writing from the Newcastle City Council, before the issue of a Construction Certificate.

CONDITIONS TO BE SATISFIED PRIOR TO THE COMMENCEMENT OF WORK AND DURING THE CONSTRUCTION PHASE

16. Toilet facilities are to be available or provided at the work site before works begin and be maintained until the works are completed, at a ratio of one toilet plus one additional toilet for every 20 persons employed at the site.

Each toilet is to:

- a) Be a standard flushing toilet connected to a public sewer, or
- b) Have an on-site effluent disposal system approved under the *Local Government Act 1993*, or
- c) Be a temporary chemical closet approved under the Local Government Act 1993.
- 17. Building demolition is to be planned and carried out in accordance with *Australian Standard 2601:2001 The Demolition of Structures*.
- 18. The demolition works are to be undertaken in accordance with Australian Standard 2601:2001 The Demolition of Structures and the following requirements:
 - a) prior to commencement of demolition works a competent person shall determine the presence of hazardous substances impacted by the proposed demolition works in accordance with Section 1.6.1 of AS2601:2001 and where required produce a Hazardous Substances Management Plan
 - b) demolition works shall be conducted in accordance with any required Hazardous Substances Management Plan. A copy of the Plan shall be kept on-site for the duration of the proposed development and a copy is to be held in the possession of the landowner
 - c) the removal, handling and disposal of any asbestos material is to be undertaken only by an asbestos removal contractor who holds the appropriate class of Asbestos Licence, issued by the WorkCover Authority of NSW
 - d) a copy of all waste disposal receipts are to be kept in the possession of the landowner and made available to authorised Council Officers upon request
 - e) seven working days notice in writing is to be given to the owners/occupiers of neighbouring premises prior to the commencement of any demolition works. Such written notice is to include the date demolition will commence and details of the name, address, contact telephone number(s) and licence details (type of licences held and licence numbers) of any asbestos removal contractor and demolition contractor, and
 - f) on sites where asbestos materials are to be removed, a standard commercially manufactured sign containing the words 'DANGER ASBESTOS REMOVAL IN PROGRESS' measuring not less than 400mm x 300mm is to be erected in a prominent position during asbestos removal works.
- 19. The demolisher is to ensure that all services (ie water, telecommunications, gas, electricity, sewerage etc), are disconnected in accordance with the relevant authority's requirements prior to demolition.
- 20. Any waste containers used in association with the proposed demolition are to be located on the site where possible.

Note: Where this is not feasible, an application is to be made for the approval to position the container on the adjacent public road in accordance with the

Newcastle City Council's adopted Building Waste Container Policy.

- 21. At a minimum, the following measures are to be implemented during the construction phase:
 - A waste container of at least one cubic metre capacity is to be provided, maintained and regularly serviced from the commencement of operations until the completion of the building, for the reception and storage of waste generated by the construction of the building and associated waste;
 - b) The waste container is to be, at minimum, constructed with a 'star' picket (corners) and weed control mat (sides), or equivalent. The matting is to be securely tied to the pickets;
 - c) Provision is to be made to prevent windblown rubbish leaving the site; and
 - d) Footpaths, road reserves and public reserves are to be maintained clear of rubbish, building materials and all other items.

Note: Fines may be issued for pollution/littering offences under the *Protection of the Environment Operations Act 1997*.

- 22. If construction / demolition work is likely to cause pedestrian or vehicular traffic in a public place to be obstructed or rendered inconvenient, or involves the need to enclose a public place, a hoarding or fence is to be erected between the work site and the public place. If necessary, an awning is to be erected, sufficient to prevent any substance from, or in connection with, the work falling into the public place. Any such hoarding, fence or awning is to be removed when the work has been completed.
- 23. An application is to be made to and approved by Newcastle City Council for the erection of a hoarding or part closure of the footway prior to construction being commenced. Such overhead structure or protective fence is to comply with the *Work Health and Safety Act 2011*, *Work Health and Safety Regulation 2011* and any relevant approved industry code of practice. Notice of intention of commencement is to be given to SafeWork NSW.
- 24. A rigid and durable sign is to be erected in a prominent position on any site on which building work, subdivision work or demolition work is being carried out, before the commencement of the work:
 - a) showing the name, address and telephone number of the Principal Certifier for building work and subdivision work, and
 - b) showing the name, address and telephone number of the Principal Contractor, if any, for any building work and a telephone number on which the Principal Contractor may be contacted at any time for business purposes, and
 - c) stating that unauthorised entry to the work site is prohibited, and
 - d) being erected in a prominent position that can be read easily by anyone in any public road or other public place adjacent to the site.
 - Any such sign is to be maintained while the building work, subdivision work or demolition work is being carried out, and must be removed when the work has been completed.

Note: This does not apply in relation to building work, subdivision work or demolition work carried out inside an existing building, if the work does not affect the external walls of the building, or Crown building work certified to comply with the Building Code of Australia under the Act, Part 6.

- 25. Building work must be carried out in accordance with the requirements of the Building Code of Australia.
- 26. In the case of residential building work for which the Home Building Act 1989 requires there to be a contract of insurance in force in accordance with Part 6 of that Act, that such a contract of insurance is in force before any building work authorised to be carried out by the consent commences.
- 27. Residential building work within the meaning of the Home Building Act 1989 must not be carried out unless the principal certifier for the development to which the work relates (not being the council) has given the council written notice of the following information -
 - (a) In the case of work for which a principal contractor is required to be appointed -
 - (i) the name and licence number of the principal contractor, and
 - (ii) the name of the insurer of the work under the Home Building Act 1989, Part 6,
 - (b) In the case of work to be carried out by an owner-builder -
 - (i) the name of the owner-builder, and
 - (ii) if the owner-builder is required to hold an owner-builder permit under the Home Building Act 1989 the number of the owner-builder permit.

If arrangements for doing the residential building work are changed while the work is in progress so that the information notified becomes out of date, further work must not be carried out unless the principal certifier for the development to which the work relates (not being the Council) has given the Council written notice of the updated information.

Note: This does not apply in relation to Crown building work certified to comply with the Building Code of Australia under Part 6 of the Act.

- 27. All excavations and backfilling are to be executed safely and excavations are to be properly guarded and protected to prevent them from being dangerous to life and property.
- 28. All building materials, plant and equipment is to be placed on the site of the development, to ensure that pedestrian and vehicular access in public places is not restricted and to prevent damage to the road reserve. The storage of building materials on Council reserves, including the road reserve, is not permitted.
- 29. Certification is to be prepared by a Registered Surveyor and submitted to the Principal Certifier at the stages of construction indicated:
 - a) On completion of ground floor construction, confirming that the floor levels are in accordance with the approved levels.
 - b) On completion of each subsequent floor level, confirming that the floor levels are in accordance with the approved levels.
 - c) When the roof has been completed, confirming that the building does not exceed the approved levels.
- 30. Certification is to be prepared by a Registered Surveyor and submitted to the Principal Certifier on completion of the retaining wall construction confirming that the location of the wall/walls is consistent with the approved location.
- 31. Any alteration to natural surface levels on the site is to be undertaken in such a manner as to ensure that there is no increase in surface water runoff to adjoining properties or that runoff is impounded on adjoining properties, as a result of the development.

- 32. The swimming pool surrounds and/or paving is to be constructed in a manner so as to ensure water from the pool overflow does not discharge onto neighbouring properties. All backwash/pool wastewater is to be piped/drained to the sewer of Hunter Water Corporation in accordance with the requirements of Hunter Water Corporation.
- 33. Pool plant and equipment is to be sited or enclosed in a sound absorbing enclosure to prevent any offensive noise (as defined under the *Protection of the Environment Operations Act 1997*) impacts to adjoining neighbours.
- 34. Construction/demolition work that generates noise that is audible at residential premises is to be restricted to the following times:
 - Monday to Friday, 7:00 am to 6:00 pm and
 - Saturday, 8:00 am to 1:00 pm.

No noise from construction/demolition work is to be generated on Sundays or public holidays.

35. Council's 'Prevent Pollution' sign is to be erected and maintained in a conspicuous location on or adjacent to the property boundary, so it is clearly visible to the public, or at other locations on the site as otherwise directed by Newcastle City Council, for the duration of demolition and construction work.

The sign can be obtained by presenting your development application receipt at City of Newcastle's Customer Enquiry Centre, Wallsend Library or the Master Builders Association Newcastle.

- 36. Erosion and sediment control measures are to be implemented prior to the commencement of works and maintained during the period of demolition and/or construction in accordance with the requirements of Managing Urban Stormwater: Soils and Construction 4th Edition Vol. 1 (the 'Blue Book') published by Landcom, 2004. Controls are not to be removed until the site is stable with all bare areas supporting an established vegetative cover.
- 37. Prior to the commencement of work, a 3.0m wide all-weather vehicle access is to be provided from the kerb and gutter to the building under construction, to reduce the potential for soil erosion. Sand or soil is not to be stockpiled on the all-weather vehicle access.
- 38. All necessary measures are to be undertaken to control dust pollution from the site. These measures are to include, but are not limited to:
 - a) Restricting topsoil removal;
 - b) Regularly and lightly watering dust prone areas (note: prevent excess watering as it can cause damage and erosion);
 - c) Alter or cease construction work during periods of high wind; and
 - d) Erect green or black shadecloth mesh or similar products 1.8m high around the perimeter of the site and around every level of the building under construction.
- 39. Where the proposed development involves the destruction or disturbance of any survey monuments, those monuments affected are to be relocated, at no cost to the Newcastle City Council, by a Surveyor registered under the *Surveying and Spatial Information Act* 2002.
- 40. All external items of air conditioning plant are to be screened or positioned in such a manner as to not detract from the visual presentation of the building.

CONDITIONS TO BE SATISFIED PRIOR TO THE ISSUE OF AN OCCUPATION CERTIFICATE, A SUBDIVISION CERTIFICATE OR A STRATA CERTIFICATE

- 41. All commitments listed in the relevant BASIX certificate for the development are to be satisfactorily completed prior to the issue of an Occupation Certificate. Should there be any changes to the specifications of the dwelling that have implications for compliance with the approved certificate, except where restricted or excluded by any other condition of consent, an amended BASIX Certificate can be relied upon as having complied with this condition. A copy of any amended BASIX Certificate is to be provided to Council within fourteen days of receipt.
- 42. All public footways, footpaving, kerbs, gutters and road pavement damaged during the works are to be immediately repaired following the damage, to a condition that provides for safe use by pedestrians and vehicles. Full restoration of the damage is to be carried out to Newcastle City Council's satisfaction prior to the completion of demolition work or prior to the issue of any Occupation Certificate in respect of development involving building work.
- 43. All works within the road reserve required by this consent are to be completed prior to the issue of a Occupation Certificate.
- 44. Any redundant existing vehicular crossing is to be removed at no cost to Newcastle City Council. The road reserve and kerb is to be restored to Newcastle City Council's satisfaction. Works are to be completed prior to the issuing of an Occupation Certificate for the proposed development.
- 45. An easement to drain water as shown on the subdivision plan (Plan Ref: 6469-SUB-1), prepared by Jason Harman and dated 2/03/2022, over the existing stormwater pipeline within the subject property, is to be created. Such easement is to be in favour of the City of Newcastle and created prior to the issue of an Occupation Certificate for the proposed development.
 - Note: All associated survey and legal work is to be undertaken by the developer at the developer's expense.
- 46. An application is to be made for a Subdivision Certificate. The application is to be supported by a digital copy (pdf format) of the survey plan of subdivision, associated administration sheets and a Section 50 Certificate from the Hunter Water Corporation.
- 47. An instrument under Section 88B of the *Conveyancing Act 1919*, setting out the terms of easements as required by this consent, along with related notations on the plan of subdivision, are to be submitted to Newcastle City Council for certification. Newcastle City Council is to be identified as a party whose consent is required to release, vary or modify easements.
- 48. Written evidence of approval by Subsidence Advisory NSW is to be obtained and submitted to the Principal Certifier prior to the issue of the Subdivision Certificate.
- 49. The approved dual occupancy (2 x three-storey dwellings) development on the site is to be completed to at least lock-up stage prior to the issue of the Subdivision Certificate.
 - Lock-up stage is taken to mean the stage at which a building's external wall cladding and roof covering is fixed, and external doors and windows are fixed (even if those doors and windows are only temporary).
- 50. Each dwelling is to be identified by the provision of house numbers on the building exterior and mailbox such that they are clearly visible from the road frontage.

The minimum numeral height is to be 75mm.

CONDITIONS TO BE SATISFIED DURING THE OPERATION AND USE THE DEVELOPMENT

51. The use and occupation of the premises, including all plant and equipment installed thereon, is not to give rise to any offensive noise, as defined under the *Protection of the Environment Operations Act 1997*.

Should Newcastle City Council consider that offensive noise has emanated from the premises, the owner/occupier of the premises will be required to submit an acoustic assessment prepared by a suitably qualified acoustical consultant recommending acoustic measures necessary to ensure future compliance with this condition and will be required to implement such measures within a nominated period. Furthermore, written certification from the said consultant, verifying that the recommended acoustic measures have been satisfactorily implemented, will be required to be submitted to Newcastle City Council prior to the expiration of the nominated period.

52. The development is allocated the following street address/es in accordance with Newcastle City Council's *House Numbering Policy* and the *Surveying and Spatial Regulation*.

Unit / Dwelling / Lot Number on plan	House Number	Street Name	Street Type	Suburb
Lot 481	26	Woodward	Street	Merewether
Lot 482	26A	Woodward	Street	Merewether

ADVISORY MATTERS

- Any proposed business identification sign or advertising sign is to be designed in accordance with the provisions of Newcastle Development Control Plan 2012 and be the subject of a separate Development Application that is to be approved prior to the sign being erected or placed in position, except when such signage meets 'exempt development' criteria.
- Retaining walls not clearly noted on the approved plans or outside of the parameters of 'exempt development', as specified in State Environmental Planning Policy (Exempt and Complying Development Codes) 2008, are to be subject to a separate development application. An application in this regard is to be approved prior to any works relating to such a retaining wall taking place.
- It is recommended that, prior to commencement of work, the free national community service 'Dial before you Dig' be contacted on 1100 or by fax on 1200 652 077 regarding the location of underground services in order to prevent injury, personal liability and even death. Inquiries should provide the property details and the nearest cross street/road.
- Any necessary alterations to public utility installations are to be at the developer/demolisher's expense and to the requirements of the City of Newcastle and any other relevant authorities. Newcastle City Council and other service authorities should be contacted for specific requirements prior to the commencement of any works.
- Any approval for fences on side boundaries, common to other private properties, is independent of any consent or agreement which may be required from any adjoining owner under the provisions of the *Dividing Fences Act 1991*.

- Prior to the occupation or use of a new building, or occupation or use of an altered portion of, or an extension to an existing building, an Occupation Certificate is to be obtained from the Principal Certifier appointed for the proposed development. An application for an Occupation Certificate must contain the information set out in Section 37 of the Environmental Planning and Assessment (Development Certification and Fire Safety) Regulation 2021 (NSW).
- It is an offence under the provisions of the *Protection of the Environment Operations Act* 1997 to act in a manner causing, or likely to cause, harm to the environment. Anyone allowing material to enter a waterway or leaving material where it can be washed off-site may be subject to a penalty infringement notice (ie 'on-the-spot fine') or prosecution.
- Failure to comply with the conditions of consent constitutes a breach of the Environmental Planning and Assessment Act 1979, which may be subject to a penalty infringement notice (ie 'on-the-spot fine') or prosecution.
- Subsidence Advisory NSW advises that it has granted approval for the subdivision subject to:
 - a) The number, size and boundaries of lots being substantially as shown on the approved plans; and
 - b) Notification being made to Subsidence Advisory NSW of any changes to lot numbering and of the registered Deposited Plan number.
- The owner of the premises on which a swimming pool/spa is situated is to ensure that the pool details are entered into the *State Swimming Pool Register*. The register is accessible at www.swimmingpoolregister.nsw.gov.au.
- A person who is aware or believes that he or she has discovered or located a relic not identified and considered in the supporting documents for this approval, in any circumstances (including where works are carried out in reliance on an exception under section 139(4)), excavation or disturbance must cease in the affected area(s) and the Heritage Council must be notified in accordance with section 146 of the Heritage Act 1977. Depending on the nature of the discovery, additional assessment and approval under the Heritage Act 1977 may be required prior to the recommencement of excavation in the affected area(s).

Note: Heritage NSW can be contacted on 02 9873 8500 or heritagemailbox@environment.nsw.gov.au. A 'relic' is any deposit, object or material evidence that relates to the settlement of New South Wales, not being Aboriginal settlement, and is of State or local significance. It is an offence under the provisions of the Heritage Act 1977 (NSW) for a person to disturb or excavate any land upon which the person has discovered a relic except in accordance with a gazetted exception or an excavation permit issued by the Heritage Council of NSW.

• If any Aboriginal objects are discovered which are not covered by a valid Aboriginal Heritage Impact Permit, excavation or disturbance of the area is to stop immediately and Heritage NSW is to be notified in accordance with section 89A of the *National Parks and Wildlife Act 1974* (NPW Act). Depending on the nature of the discovery, additional assessment and approval under the NPW Act may be required prior to works continuing in the affected area(s). Aboriginal objects in NSW are protected under the NPW Act. Unless the objects are subject to a valid Aboriginal Heritage Impact Permit, work must not recommence until approval to do so has been provided by Heritage NSW.

Note: Heritage NSW can be contacted on 02 9873 8500 or heritagemailbox@environment.nsw.gov.au. An 'Aboriginal object' is any deposit,

object or other material evidence (not being a handicraft made for sale) relating to the Aboriginal habitation of an area of New South Wales, being habitation before or concurrent with (or both) the occupation of that area by persons of non-Aboriginal extraction, and includes Aboriginal remains. It is an offence under the provisions of the *National Parks and Wildlife Act 1974* (NPW Act) for a person to harm or desecrate an Aboriginal object, with defence from prosecution and certain activities exempt as prescribed under the NPW Act.

END OF CONDITIONS

SCHEDULE 2

REASONS FOR THE DETERMINATION & CONSIDERATION OF COMMUNITY VIEWS

The determination decision was reached for the following reasons:

- The proposed development, subject to the recommended conditions, is consistent with the objectives of the applicable environmental planning instruments, being; Newcastle Local Environmental Plan 2012 (NLEP) and applicable State Environmental Planning Policies.
- The proposal is considered acceptable in relation to the objection under Clause 4.6 Exceptions to Development Standards of the NLEP 2012, against the development standard at Clause 4.3 Height of buildings and considers the objection to be justified in the circumstances consistent with the objectives of Clause 4.3 and the objectives of the R2 Low Density Residential zone under NLEP 2012.
- The proposed development is, subject to the recommended conditions, consistent with the objectives of the Newcastle Development Control Plan 2012 (NDCP).
- The proposed development is considered to be of an appropriate scale and form for the site and the character of the locality.
- The proposed development has appropriate management and mitigation of impacts through conditions of consent.
- The proposed development, subject to the recommended conditions, will not result in unacceptable adverse impacts upon the natural or built environments.
- The proposed development is a suitable and planned use of the site and its approval is within the public interest.

REASONS WHY THE CONDITIONS HAVE BEEN IMPOSED

The following conditions are applied to:

- Confirm and clarify the terms of Council's determination;
- Identify modifications and additional requirements that will result in improved compliance, development and environmental outcomes;
- Prevent, minimise, and/or offset adverse environmental impacts including economic and social impacts;
- Set standards and measures for acceptable environmental performance; and
- Provide for the ongoing management of the development.

ATTACHMENTS DISTRIBUTED UNDER SEPARATE COVER

DAC 06/12/22 – 26 WOODWARD STREET MEREWETHER – DA2022/00382 AND DUAL OCCUPANCY – INCLUDES DEMOLITION AND SUBDIVISION (2 LOTS) TORRENS TITLE

ITEM-25 Attachment C: Processing Chronology

THE CITY OF NEWCASTLE Report to Development Applications Committee Meeting on 6 December 2022



PROCESSING CHRONOLOGY

DA2022/00382 - 26 Woodward Street Merewether

11 April 2022	-	Application lodged
13 April 2022 to 4 May 2022	-	Application notified in accordance with CN's Community Participation Plan (CPP)
26 October 2022	-	Request for additional information issued: additional heights / levels to be shown on retaining walls on plan
31 October 2022	-	Revised architectural Plans received

ATTACHMENTS DISTRIBUTED UNDER SEPARATE COVER

DAC 06/12/22 – 26 WOODWARD STREET MEREWETHER – DA2022/00382 AND DUAL OCCUPANCY – INCLUDES DEMOLITION AND SUBDIVISION (2 LOTS) TORRENS TITLE

ITEM-25 Attachment D: Subsidence Advisory NSW approval



Subsidence Advisory

117 Bull Street, Newcastle West, NSW, 2302 | **T**: (02) 4908 4300 99 Menangle Street, Picton, NSW, 2571 | **T**: (02) 4677 6500 **24 Hour Emergency Service:** 1800 248 083 (Free Call)

FNFN69-05818N0 TSUB22-00088

Land Development Solutions

Dear Land Development Solutions

RE PROPOSED ONE INTO TWO LOT TORRENS TITLE SUBDIVISION AT 26 WOODWARD STREET MEREWETHER; LOT 48 DP 39230; TSUB22-00088

NOTICE OF DETERMINATION

I refer to the application detailed above. Subsidence Advisory NSW has determined to grant approval under section 22 of the *Coal Mine Subsidence Compensation Act 2017*.

Approval has been granted, subject to the conditions set out in the attached determination under Schedule 2. The stamped approved plans are attached.

Once relevant documentation to meet the conditions in Schedule 2 is available, please email through to subsidencedevelopment@customerservice.nsw.gov.au quoting reference **TSUB22-00088**.

Should you have any questions about the determination, I can be contacted by phone on 02 4908 4300 or via email at subsidencedevelopment@customerservice.nsw.gov.au.

Yours faithfully,

Melanie Fityus Senior Risk Engineer

30 March 2022

DETERMINATION

Issued in accordance with section 22 of the Coal Mine Subsidence Compensation Act 2017

As delegate for Subsidence Advisory NSW under delegation executed 30 March 2022 approval is for the development described in Schedule 1, subject to the conditions attached in Schedule 2.

Determination Date: 30 March 2022

Approval to Lapse on: 30 March 2027

The conditions of approval are imposed for the following reasons:

- a) To confirm and clarify the terms of Subsidence Advisory NSW approval.
- b) To minimise the risk of damage to surface development from mine subsidence.

Melanie Fityus Senior Risk Engineer

30 March 2022

SCHEDULE 1

Application No: TSUB22-00088

Applicant: LAND DEVELOPMENT SOLUTIONS

Site Address: 26 WOODWARD STREET MEREWETHER

Lot and DP: LOT 48 DP 39230

Proposal: ONE INTO TWO LOT TORRENS TITLE SUBDIVISION

Mine Subsidence District: **NEWCASTLE**

SCHEDULE 2

CONDITIONS OF APPROVAL

GENERAL Plans. Standards and Guidelines The development being undertaken strictly in accordance with the details set out on the 1. application form, any information submitted with the application and the plans submitted, as amended or as modified by the conditions of this approval. Note: Any proposal to modify the terms or conditions of this approval, whilst still maintaining substantially the same development to that approved, will require the submission of formal advice for consideration by Subsidence Advisory NSW. amendments to the design result in the development not remaining substantially the same as that approved by this approval, a new application must be submitted to Subsidence Advisory NSW. 2. This approval expires 5 years after the date the approval was granted if subdivision works have not physically commenced. 3. Subsidence Advisory NSW must be notified of any changes to lot numbering and the registered DP number. Approval under section 22 of the Coal Mine Subsidence Compensation Act 2017 is also 4. required for the erection of all improvements on the land. As a guide, improvements shall comply with Subsidence Advisory NSW nominated Surface Development Guidelines, or otherwise assessed on merit.

Dispute Resolution

If you are dissatisfied with the determination of this application, an appeal may be formally submitted with the Chief Executive Officer for an independent internal review. The application must be made in writing and must provide reasons why the determination should be changed.

ATTACHMENTS DISTRIBUTED UNDER SEPARATE COVER

DAC 06/12/22 – 26 WOODWARD STREET MEREWETHER –
DA2022/00382 AND DUAL OCCUPANCY – INCLUDES DEMOLITION
AND SUBDIVISION (2 LOTS) TORRENS TITLE

ITEM-25 Attachment E: Clause 4.6 variation request



Clause 4.6 Exception to Development

Standard – Clause 4.3 – Height of Buildings

Newcastle LEP 2012

Demolition of existing dwelling & associated structures, construction of dual occupancy & Torrens Title

Subdivision

26 Woodward Street, Merewether Lot 48 in DP 39230

Prepared: March 2022 Reference: 6469

Client: Nicole and Stephen Burns

Introduction

This written request is submitted seeking a variation to a development standard under Clause 4.6 Exceptions to Development Standards of the Newcastle Local Environmental Plan 2012 (NLEP); and adopts the format of Council's prescribed form to vary a Development Standard.

The development standard for which the variation is sought is Clause 4.3 (Height of Buildings) pursuant to the NLEP. The Height of Building Map prescribes a maximum HOB for the Site of 8.5m.

This application has been prepared in accordance with the NSW Department of Planning and Environment guidelines and has incorporated relevant principles identified in various Land and Environment Court decisions.

This request is made on the basis that:

- a) compliance with the development standard is unreasonable and unnecessary in the circumstances of the case,
- b) that there are sufficient environmental planning grounds to justify contravening the development standard,
- c) it is consistent with the objectives of the LEP, the particular standard and the zone in which the development is proposed to be carried out, and
- d) it is in the public interest to allow a departure from the numerical standard in this case.

An application is sort under Clause 4.6 Exceptions to development standards of Newcastle LEP 2012

- (1) The objectives of this clause are as follows:
 - (a) to provide an appropriate degree of flexibility in applying certain development standards to particular development,
 - (b) to achieve better outcomes for and from development by allowing flexibility in particular circumstances.
- (2) Development consent may, subject to this clause, be granted for development even though the development would contravene a development standard imposed by this or any other environmental planning instrument. However, this clause does not apply to a development standard that is expressly excluded from the operation of this clause.
- (3) Development consent must not be granted for development that contravenes a development standard unless the consent authority has considered a written request from the applicant that seeks to justify the contravention of the development standard by demonstrating:
 - (a) that compliance with the development standard is unreasonable or unnecessary in the circumstances of the case, and
 - (b) that there are sufficient environmental planning grounds to justify contravening the development standard.
- (4) Development consent must not be granted for development that contravenes a development standard unless:
 - (a) the consent authority is satisfied that:
 - (i) the applicant's written request has adequately addressed the matters required to be demonstrated by subclause (3), and
 - (ii) the proposed development will be in the public interest because it is consistent with the objectives of the particular standard and the objectives for development within the zone in which the development is proposed to be carried out, and
 - (b) the concurrence of the Secretary has been obtained.

What is the zoning of the land and what are the objectives of the zone?

The subject site is zoned R2 Low Density Residential under Newcastle Local Environmental Plan 2012

Objectives of the zone:

- To provide for the housing needs of the community within a medium density residential environment.
- To provide a variety of housing types within a medium density residential environment.

- To enable other land uses that provide facilities or services to meet the day to day needs of residents.
- To allow some diversity of activities and densities if:
 - (i) the scale and height of proposed buildings is compatible with the character of the locality, and
 - (ii) there will be no significant adverse impact on the amenity of any existing nearby development.
 - To encourage increased population levels in locations that will support the commercial viability of centres provided that the associated new development:
 - (i) has regard to the desired future character of residential streets, and
 - (ii) does not significantly detract from the amenity of any existing nearby development.

Identify the Development Standard to which this Clause 4.6 variation applies?

Clause 4.3 Height of Buildings

Development Standard Being Varied?

The development standard being varied is the Height of Buildings standard.


Under What Clause is the Development Standard listed in the EPI?

The development standard being varied is prescribed under Clause 4.3(2) of NLEP2012. An extract of the applicable relevant provision is set out below:

4.3 Height of Buildings

(2) The height of a building on any land is not to exceed the maximum height shown for the land on the Height of Buildings Map.

The Height of Buildings map extract is shown below, noting that the site is prescribed with a maximum Height of Building standard of 8.5m.

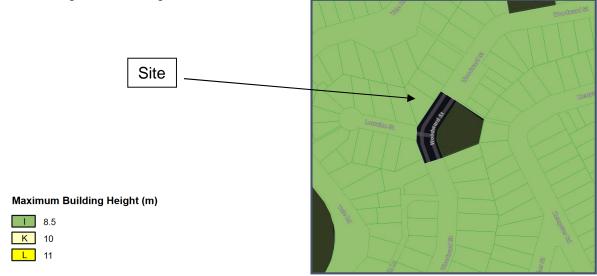

What are the Objectives of the Development Standards?

Newcastle Local Environmental Plan 2012 Clause 4.3 Height of Buildings

- (1) The objectives of this clause are as follows:
 - (a) to ensure the scale of development makes a positive contribution towards the desired built form, consistent with the established centres hierarchy,
 - (b) to allow reasonable daylight access to all developments and the public domain
- (2) The height of a building on any land is not to exceed the maximum height shown for the land on the Height of Buildings Map.


What is the numeric value of the development standard in the EPI?

The maximum Height of Building is 8.5m.

What is the proposed numeric value of the development standard, the percentage variation in your Development Application?

The development proposes a maximum Height of Building of 9.571m of proposed dwelling one, due to the existing slope of the site.

Height of Building			
Current Height of Building (m)	Maximum Height of Building (m)	Proposed Height of Building Size (m)	Percentage Variation (%)
n/a	8.5	9.57	12.6

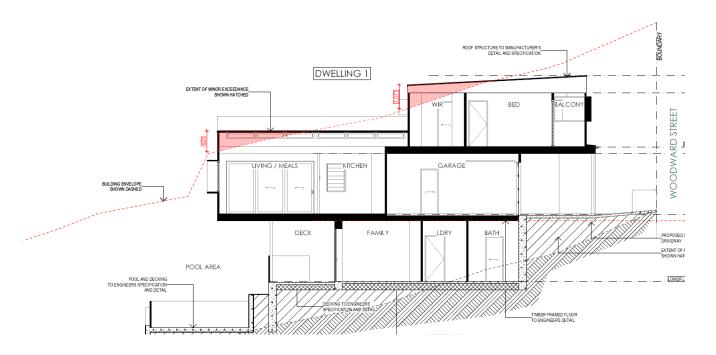

How is strict compliance with the development standard unreasonable or unnecessary in this particular case?

The overall building mass of the dual occupancy dwelling is well within the LEP maximum height limit. The extent of the height non-compliance is limited centrally to the site and does not impose any overshadowing or privacy issues as demonstrated in the Statement of Environmental Effects. The height departure will not affect adjoining development or the development itself in terms of excessive bulk as the departure is minor in scale compared to the overall site. As viewed from Woodward street the proposed dwellings are meters under the LEP height limit

Under LEC ruling of *Wehbe v Pittwater Council* [2007] *NSW LEC* 827, the most common way of demonstrating that compliance is unreasonable or unnecessary, was whether the proposal met the objectives of the standard regardless of the non-compliance. Under *Four2Five*, whilst this can still be considered under this heading, it is also necessary to consider it under Clause 4.6(3)(a).

The Five ways described in *Wehbe* are therefore appropriately considered in this context, as follows:

The objectives of the standard are achieved notwithstanding non-compliance with the standard;

The objectives of the standard have been outlined at the commencement of this report, a response to each of the objectives is provided below:

(a) to ensure the scale of development makes a positive contribution towards the desired built form, consistent with the established centres hierarchy,

The proposed departure is central to the site and is not visible from Woodward Street. Due to the orientation the departure does not cause any additional solar impacts on adjoining dwellings.

(b) to allow reasonable daylight access to all developments and the public domain

As displayed on the shadow diagrams included in the Architectural plans there is no additional impact on shadowing due to the departure.

(2) The height of a building on any land is not to exceed the maximum height shown for the land on the Height of Buildings Map.

The departure is purely the roof form of proposed dwelling one consisting of an area of approx. 15m² within the 646.7m² site.

For the reasons set out above, the objectives of the standard are considered to be satisfied.

2. The underlying objective or purpose of the standard is not relevant to the development and therefore compliance is unnecessary;

The exception request does not rely on this consideration.

3. The underlying object or purpose would be defeated or thwarted if compliance was required and therefore compliance is unreasonable;

Strick compliance to the HOB would hinder the functionality of the proposed dwelling one in that the overall development application proposes to provide an infill housing opportunity that creates two moderately sized detached dwelling on Torrens Title lots close to the city CBD. The objective of the residential zoning is to encourage greater inner-city density where possible without compromising the amenity and functionality to the dwellings or the surrounds. As these objectives are achieved within the proposal by allowing the slight departure to ensure amenity and functionality for proposed dwelling one is achieved whilst providing the desired density for the area.

4. The development standard has been virtually abandoned or destroyed by the Council's own actions in granting consents departing from the standard and hence complying with the standard is unnecessary and unreasonable.

The proposal is as a majority well within the 8.5 maximum height limited however the site is located within a steep area of Merewether where Council has taken the practical approach over the years to consider these minor departures in order to utilise steeper sloping sites to achieve the zoning density objectives desired by Council.

5. The compliance with the development standard is unreasonable or inappropriate due to existing use of the land and current environmental character of the particular parcel of land. That is, the particular parcel of land should not have been included in the zone.

The zoning of the land is appropriate for the site. This exception request does not rely on this consideration.

The site is strategically located close to the Newcastle CBD and the nature of the departure is minor and unobtrusive within its surrounds.

In addition to demonstrating that Wehbe "1" is satisfied, strict compliance with the standard is also considered to be unreasonable and unnecessary in the circumstances of this case for the following reasons:

• In Moskovich v Waverley Council, the LEC accepted that compliance with the standard (HOB in that case) was unreasonable and unnecessary because the

design achieved the objectives of the standard and the respective zone, in a way that addressed the particular circumstances of the site and resulted in a better streetscape and internal and external amenity outcome than a complying development.

- The proposal for the subject site achieves a similar outcome in that it responds appropriately to surrounding & existing built form; provides an architectural design which strengthens the buildings presentation and appropriately promotes the desired future residential character.
- The development scheme has been designed with due consideration to existing site context and surrounding built form. In particular, the built form has been improved without increasing the buildings bulk and maintains a respectful interface with adjoining residences.
- Overall, the design approach to the subject site is consistent with those considerations in *Moskovich v Waverley Council*, and strict compliance with the HOB control over this site is considered unreasonable and unnecessary in this instance.

Accordingly, compliance with the standard is considered to be unreasonable and unnecessary in the circumstances of the case.

Is the development standard a performance based control?

No

Would strict compliance with the standard, in your particular case, would be unreasonable or unnecessary? Why?

The subject site is a sloping site and the proposed dwellings will present to the street as a standard 2 storey dwelling standing around 6.28m at the highest point above the existing ground level and well within the 8.5m maximum height limit.



The proposed floor to ceiling heights are the minimum 2.75m and 2.45m and compliant to the DCP minimum floor to ceiling height requirements. The proposed roof is a low profile roof in keeping with the more modern roofing style of the area. All of these abovementioned design choices have been made in order to establish the least amount of departure to the LEP height limit. The departure is merely due to the slope of the site and resultant existing ground level. The dwellings are not an excessive in size with floor areas of $180m^2$ and $191m^2$ and is similar to the surrounding dwellings in floor area. It is clear that the departure is not a result of an excessively large dwelling, high ceilings or architectural featured roof and therefore any alterations to the proposed design to achieve a compliant building height would greatly impact on the owners amenity and the functionality of the dwelling. It would further reduce the size of the dwelling and possibly make it no longer a desirable family sized home. The proposed development is a considered approach with a mix of housing options being 3 & 4 bedroom dwellings. Both of which are desirable family sized homes offering the area a much needed variety of housing stock as opposed to smaller townhouse style new construction.

Are there sufficient environmental grounds to justify contravening the development standard?

Strict compliance would require the loss of residential density on a site that is centrally located and well serviced. This does not represent the proper management of resources or the orderly and economic use of land. The proposed residential housing will each have its own Torrens title lot and be within the character of the area

Further, it would be a poor planning outcome as it would place more pressure on peripheral locations to supply housing to meet the requirements of the city. As such, the proposed development is consistent with the provisions of orderly and economic development. A development that is in the public interest and demonstrates that it is consistent with the objectives of development standards within that zoning should be supported given that strict compliance would merely result in a built form that is inconsistent with its surrounds due to the resulting smaller compacted nature of the resultant design.

Given the minor nature of the non-compliance, there are no material impacts that result from the non-compliance, than a fully compliant development would present. In addition, there are no detrimental amenity impacts resulting from the development when considered in its entirety.

Pursuant to case law in Ex Gratia P/L v Dungog Council (NSWLEC 148), the question that needs to be answered is 'whether the public advantages of the proposed development outweigh the public disadvantages of the proposed development'.

There is no public benefit in maintaining strict compliance with the development standard given that there are no unreasonable impacts that will result from the standard. Rather, the redevelopment of the site will facilitate additional housing opportunities within a well established residential area. If the maximum height were to be enforced the result would still be a 2 dwelling development but with a compromised design for both dwellings resulting in a smaller less desirable design. The proposal is providing family homes as opposed to smaller townhouse style developments and with a location close to shopping centers, schools and the inner city in a area that has a higher demand for family residences. As demonstrated in the Architectural plans the proposed height departure does not create any additional overshadowing impact or obstructs any views from adjoining lots. The design of the dwellings respect the surrounds and complements the emerging streetscape through good Architectural design, therefore the public benefits greatly outweighs any disadvantages in this instance

Is the variation well founded?

The proposal before Council provides for a well-considered development that responds to the context of the site and its surrounds and Councils planning principles. It is considered that this submission provides sufficient environmental planning grounds to justify contravening the development standards, noting the development will be in the public interest. The proposed outcome is a sensitive, respectful, well considered and balanced proposal. The design relates sensibly & responsibly to the site context and existing conditions with particular regard to the amenity of the occupants and the surrounding neighbours. The proposal seeks to maximise the legitimate redevelopment opportunities of the site without denying or reducing the amenity of the area. It is considered that the departure from the LEP maximum height is of a relatively minor nature given the overall site massing proposed and the high Architectural aspect of the proposal. It is considered that there is no benefit to the public or the community in maintaining the development standards. The proposed development will allow for the creation of a high quality residential development better suited to the site than the existing older style dwelling with detached garaging which as stated above meets the desired objectives of the standard and zone objectives.

It is not considered that the variation sought raises any matter of significance for state or regional environmental planning. The departure from the height of building control within the Newcastle LEP 2012 allows for the orderly and economic use of the site in a manner which achieves the outcomes and objectives of the relevant planning controls.

The relevant considerations of Clause 4.6 of the Newcastle LEP 2012 have been discussed above, and support contravention of the development standard for this instance. This report has systematically addressed the matters required to be demonstrated by sub clause (3), and satisfied the considerations required to be made by Council under Clause 4.6(4)(a)(i). The deviation from the prescribed Height of Building is consistent with the zone objectives and the objectives of the development standard in Clause 4.3 and Council may be satisfied that it is in the public interest pursuant to clause 4.6(4)(a)(ii).

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Having evaluated the likely affects arising from this non-compliance, we are satisfied that the objectives of Clause 4.6 of the Newcastle LEP 2012 are satisfied as the departure from the controls does not create any adverse environmental impacts.

Consequently, strict compliance with this development standard is unreasonable and unnecessary in this particular instance, and that the use of Clause 4.6 of the Newcastle LEP 2012 to vary this development controls is appropriate in this instance.

Based on the above assessment, it is reasonable to conclude that strict compliance with the Height of Building is not necessary and that a better planning outcome is achieved for this development by allowing flexibility in this instance.