ATTACHMENTS DISTRIBUTED UNDER SEPARATE COVER

PV 16/08/22 – 49 CARRINGTON PARADE, NEW LAMBTON –
DA2021/01185 – DWELLING HOUSE – DEMOLITION OF EXISTING
STRUCTURES AND ERECTION OF TWO STOREY HOUSE
INCLUDING ANCILLARY DEVELOPMENT (POOL AND RETAINING
WALLS)

PAGE 3 ITEM-1 Attachment A: Submitted Plans

PAGE 34 ITEM-1 Attachment B: View Analysis

ATTACHMENTS DISTRIBUTED UNDER SEPARATE COVER

PV 16/08/22 – 49 CARRINGTON PARADE, NEW LAMBTON –
DA2021/01185 – DWELLING HOUSE – DEMOLITION OF EXISTING
STRUCTURES AND ERECTION OF TWO STOREY HOUSE
INCLUDING ANCILLARY DEVELOPMENT (POOL AND RETAINING
WALLS)

ITEM-1 Attachment A: Submitted Plans

FORTY-NINE CARRINGTON

49 CARRINGTON PARADE, NEW LAMBTON, NSW, 2305 LOT 2 / DP 500453

ARCHIE MORONEY

DRAWING LIST

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AMENDMENTS MADE SINCE LAST REVISION

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FORTY-NINE CARRINGTON

CLIENT PROJECT NO. ARCHIE MORONEY 2020-184

COVER PAGE

49 CARRINGTON PARADE, NEW LAMBTON, NSW, 2305 ISSUE NO. SCALE DD000 @A3



BASIX COMMITMENTS

Schedule of BASIX commitments

The commitments set out below regulate how the proposed development is to be carried out. It is a condition of any development consent granted, or complying development certificate issued, for the proposed development, that BASIX commitments be complied with.

Water Commitments	Show on DA plans	Show on CC/CDC plans & specs	Certifier check
Landscape			
The applicant must plant indigenous or low water use species of vegetation throughout 30 square metres of the site.	~	~	
Fixtures			
The applicant must install showerheads with a minimum rating of 4 star (> 6 but <= 7.5 L/min plus spray force and/or coverage tests) in all showers in the development.		~	~
The applicant must install a toilet flushing system with a minimum rating of 5 star in each toilet in the development.		~	~
The applicant must install taps with a minimum rating of 5 star in the kitchen in the development.		~	
The applicant must install basin taps with a minimum rating of 5 star in each bathroom in the development.		~	
Alternative water			
Rainwater tank			
The applicant must install a rainwater tank of at least 8000 litres on the site. This rainwater tank must meet, and be installed in accordance with, the requirements of all applicable regulatory authorities.	~	~	~
The applicant must configure the rainwater tank to collect rain runoff from at least 218.2 square metres of the roof area of the development (excluding the area of the roof which drains to any stormwater tank or private dam).		~	~
The applicant must connect the rainwater tank to:			
all toilets in the development		-	_
the cold water tap that supplies each clothes washer in the development			
 at least one outdoor tap in the development (Note: NSW Health does not recommend that rainwater be used for human consumption in areas with potable water supply.) 		•	V
Swimming pool			
The swimming pool must not have a volume greater than 50 kilolitres.	_	~	
The swimming pool must be outdoors.	_	~	

Thermal Comfort Commitments	Show on DA plans	Show on CC/CDC plans & specs	Certifie check
General features			
The dwelling must not have more than 2 storeys.	~	~	-
The conditioned floor area of the dwelling must not exceed 300 square metres.	~	~	~
The dwelling must not contain open mezzanine area exceeding 25 square metres.		~	~
The dwelling must not contain third level habitable attic room.	~	~	-
Floor, walls and ceiling/roof			<u>'</u>
The applicant must construct the floor(s), walls, and ceiling/roof of the dwelling in accordance with the specifications listed in the table below.		~	-

Construction	Additional insulation required (R-Value)	Other specifications
floor - concrete slab on ground, 156.82 square metres	nil	
floor - above habitable rooms or mezzanine, 117.23 square metres, concrete	nil	
external wall - brick veneer	1.86 (or 2.40 including construction)	
external wall - framed (weatherboard, fibre cement, metal clad)	2.00 (or 2.40 including construction)	
internal wall shared with garage - plasterboard	nil	
ceiling and roof - flat ceiling / pitched roof	ceiling: 1.7 (up), roof: foil backed blanket (55 mm)	unventilated; light (solar absorptance < 0.475)
ceiling and roof - raked ceiling / pitched or skillion roof, framed	ceiling: 2 (up), roof: foil backed blanket (55 mm)	framed; light (solar absorptance < 0.475)
ceiling and roof - flat ceiling / flat roof, framed	ceiling: 1.9 (up), roof: foil backed blanket (55 mm)	framed; light (solar absorptance < 0.475)

Note	In some climate zones, insulation should be in	stalled with due consideration of condensation and associated interaction with adjoin	ing building materials.
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SCRIPTION	
R DEVELOPMENT PROVAL	

DATE	4/08/	
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FORTY-NINE CARRINGTON

CLIENT

ARCHIE MORONEY

BASIX COMMITMENTS -

Thermal Comfort Commitments

49 CARRINGTON PARADE, NEW ISSUE NO. SCALE @A3

	DA plans	plans & specs	check
Nindows, glazed doors and skylights			
The applicant must install the windows, glazed doors and shading devices described in the table below, in accordance with the specifications listed in the table. Relevant overshadowing specifications must be satisfied for each window and glazed door.	~	~	~
The dwelling may have 1 skylight (<0.7 square metres) which is not listed in the table.	~	~	~
The following requirements must also be satisfied in relation to each window and glazed door:	~	~	~
For the following glass and frame types, the certifier check can be performed by visual inspection.			-
- Aluminium single clear			
- Aluminium double (air) clear			
- Timber/uPVC/fibreglass single clear			
- Timber/uPVC/fibreglass double (air) clear			
 For other glass or frame types, each window and glazed door must be accompanied with certification showing a U value no great than that listed and a Solar Heat Gain Coefficient (SHGC) within the range of those listed. Total system U values and SHGC mu be calculated in accordance with National Fenestration Rating Council (NFRC) conditions. Frame and glass types shown in the table below are for reference only. 			~

Window/glazed door no.	Maximum height (mm)	Maximum width (mm)	Туре	Shading Device (Dimension within 10%)	Overshadowing
North facing					
GD02	3000	2650	U-value: 5.6, SHGC: 0.369 - 0.451 (aluminium, single, Lo-Tsol Low-e)	solid overhang 8890 mm, 10 mm above head of window or glazed door	not overshadowed
W04	1800	600	U-value: 5.6, SHGC: 0.369 - 0.451 (aluminium, single, Lo-Tsol Low-e)	solid overhang 2600 mm, 600 mm above head of window or glazed door	not overshadowed
W05	600	1400	U-value: 5.6, SHGC: 0.369 - 0.451 (aluminium, single, Lo-Tsol Low-e)	none	not overshadowed
W106	2140	2650	U-value: 5.6, SHGC: 0.369 - 0.451 (aluminium, single, Lo-Tsol Low-e)	solid overhang 600 mm, 0 mm above head of window or glazed door	not overshadowed
W108	1800	1210	U-value: 5.6, SHGC: 0.369 - 0.451 (aluminium, single, Lo-Tsol Low-e)	solid overhang 600 mm, 0 mm above head of window or glazed door	not overshadowed
East facing	<u>'</u>		'		'
GD01	3000	2650	U-value: 5.6, SHGC: 0.369 - 0.451 (aluminium, single, Lo-Tsol Low-e)	solid overhang 1500 mm, 10 mm above head of window or glazed door	not overshadowed
W02	3300	1690	U-value: 5.6, SHGC: 0.369 - 0.451 (aluminium, single, Lo-Tsol Low-e)	eave 750 mm, 450 mm above head of window or glazed door	not overshadowed
W03	3000	3850	U-value: 5.6, SHGC: 0.369 - 0.451 (aluminium, single, Lo-Tsol Low-e)	eave 1050 mm, 3170 mm above head of window or glazed door	not overshadowed
GD03	3000	5290	U-value: 5.6, SHGC: 0.369 - 0.451 (aluminium, single, Lo-Tsol Low-e)	solid overhang 5350 mm, 10 mm above head of window or glazed door	not overshadowed
W102	1030	2050	U-value: 5.6, SHGC: 0.369 - 0.451 (aluminium, single, Lo-Tsol Low-e)	eave 600 mm, 1520 mm above head of window or glazed door	not overshadowed
W104	1030	2050	U-value: 5.6, SHGC: 0.369 - 0.451 (aluminium, single, Lo-Tsol Low-e)	eave 1050 mm, 450 mm above head of window or glazed door	not overshadowed
W105	2140	3850	U-value: 5.6, SHGC: 0.369 - 0.451 (aluminium, single, Lo-Tsol Low-e)	eave 1050 mm, 450 mm above head of window or glazed door	not overshadowed
GD101	2400	3850	U-value: 5.6, SHGC: 0.369 - 0.451 (aluminium, single, Lo-Tsol Low-e)	solid overhang 600 mm, 0 mm above head of window or glazed door	not overshadowed
W107	600	2100	U-value: 5.6, SHGC: 0.369 - 0.451 (aluminium, single, Lo-Tsol Low-e)	solid overhang 600 mm, 0 mm above head of window or glazed door	not overshadowed
South facing					
W01	3000	1700	U-value: 5.6, SHGC: 0.369 - 0.451 (aluminium, single, Lo-Tsol Low-e)	none	not overshadowed
W101	1030	2050	U-value: 5.6, SHGC: 0.369 - 0.451 (aluminium, single, Lo-Tsol Low-e)	eave 600 mm, 1260 mm above head of window or glazed door	not overshadowed
W103	1030	2050	U-value: 5.6, SHGC: 0.369 - 0.451 (aluminium, single, Lo-Tsol Low-e)	eave 900 mm, 600 mm above head of window or glazed door	not overshadowed
West facing					
W06	730	3000	U-value: 5.6, SHGC: 0.369 - 0.451 (aluminium, single, Lo-Tsol Low-e)	none	not overshadowed
W07	600	2100	U-value: 5.6, SHGC: 0.369 - 0.451 (aluminium, single, Lo-Tsol Low-e)	eave 2100 mm, 3400 mm above head of window or glazed door	not overshadowed
W08	600	1450	U-value: 5.6, SHGC: 0.369 - 0.451 (aluminium, single, Lo-Tsol Low-e)	none	not overshadowed
W109	1500	730	U-value: 5.6, SHGC: 0.369 - 0.451 (aluminium, single, Lo-Tsol Low-e)	eave 730 mm, 360 mm above head of window or glazed door	not overshadowed
W110	600	2050	U-value: 5.6, SHGC: 0.369 - 0.451 (aluminium, single, Lo-Tsol Low-e)	eave 730 mm, 360 mm above head of window or glazed door	not overshadowed
W111	600	2100	U-value: 5.6, SHGC: 0.369 - 0.451 (aluminium, single, Lo-Tsol Low-e)	eave 2100 mm, 210 mm above head of window or glazed door	not overshadowed

BASIX COMMITMENTS

Energy Commitments	Show on DA plans	Show on CC/CDC plans & specs	Certifi check		
Hot water					
The applicant must install the following hot water system in the development, or a system with a higher energy rating: gas instantaneous with a performance of 5 stars.	~	✓	-		
Cooling system					
The applicant must install the following cooling system, or a system with a higher energy rating, in at least 1 living area: 3-phase airconditioning; Energy rating: EER 3.5 - 4.0		~	-		
The applicant must install the following cooling system, or a system with a higher energy rating, in at least 1 bedroom: 3-phase airconditioning; Energy rating: EER 3.5 - 4.0		~	V		
The cooling system must provide for day/night zoning between living areas and bedrooms.		V			
Heating system					
The applicant must install the following heating system, or a system with a higher energy rating, in at least 1 living area: 3-phase airconditioning; Energy rating: EER 3.5 - 4.0		~	-		
The applicant must install the following heating system, or a system with a higher energy rating, in at least 1 bedroom: 3-phase airconditioning; Energy rating: EER 3.5 - 4.0		~	•		
The heating system must provide for day/night zoning between living areas and bedrooms.		~	•		
Ventilation			_		
The applicant must install the following exhaust systems in the development:					
At least 1 Bathroom: individual fan, ducted to façade or roof; Operation control: manual switch on/off					
Kitchen: individual fan, ducted to façade or roof; Operation control: manual switch on/off		j	J		
Laundry: individual fan, ducted to façade or roof; Operation control: manual switch on/off					
Artificial lighting					
The applicant must ensure that the "primary type of artificial lighting" is fluorescent or light emitting diode (LED) lighting in each of the following rooms, and where the word "dedicated" appears, the fittings for those lights must only be capable of accepting fluorescent or ight emitting diode (LED) lamps:					
at least 4 of the bedrooms / study; dedicated					
at least 3 of the living / dining rooms; dedicated					
the kitchen; dedicated					
all bathrooms/toilets; dedicated					
the laundry; dedicated					
all hallways; dedicated			j		
Natural lighting					
The applicant must install a window and/or skylight in 3 bathroom(s)/toilet(s) in the development for natural lighting.					
Swimming pool					
The applicant must install the following heating system for the swimming pool in the development (or alternatively must not install any neating system for the swimming pool): solar only					
The applicant must install a timer for the swimming pool pump in the development.		•			
Alternative energy					
The applicant must install a photovoltaic system with the capacity to generate at least 1.2 peak kilowatts of electricity as part of the development. The applicant must connect this system to the development's electrical system.		~	V		
Other					
The applicant must install an induction cooktop & electric oven in the kitchen of the dwelling.					
The applicant must construct each refrigerator space in the development so that it is "well ventilated", as defined in the BASIX definitions.		✓			
The applicant must install a fixed outdoor clothes drying line as part of the development.		•			
		•			

DRAWING BASIX COMMITMENTS -SHEET 2 PROJECT NO.



P +61 2 4969 3631
E HELLO@SDARCH.COM.AU
A SUITE 1, LEVEL 1, 187 UNION ST,
THE JUNCTION NSW 2291
SDARCH.COM.AU

PROJECT FORTY-NINE CARRINGTON

CLIENT ARCHIE MORONEY

drawing STREET PERSPECTIVE

PROJECT NO. 2020-184

LOCATION 49 CARRINGTON PARADE, NEW LAMBTON, NSW, 2305

drawing no. DD003 ISSUE NO. 08 scale @A3









FB1 FACE BRICKWORK






STN STONE CLADDING



P +61 2 4969 3631 **E** HELLO@SDARCH.COM.AU

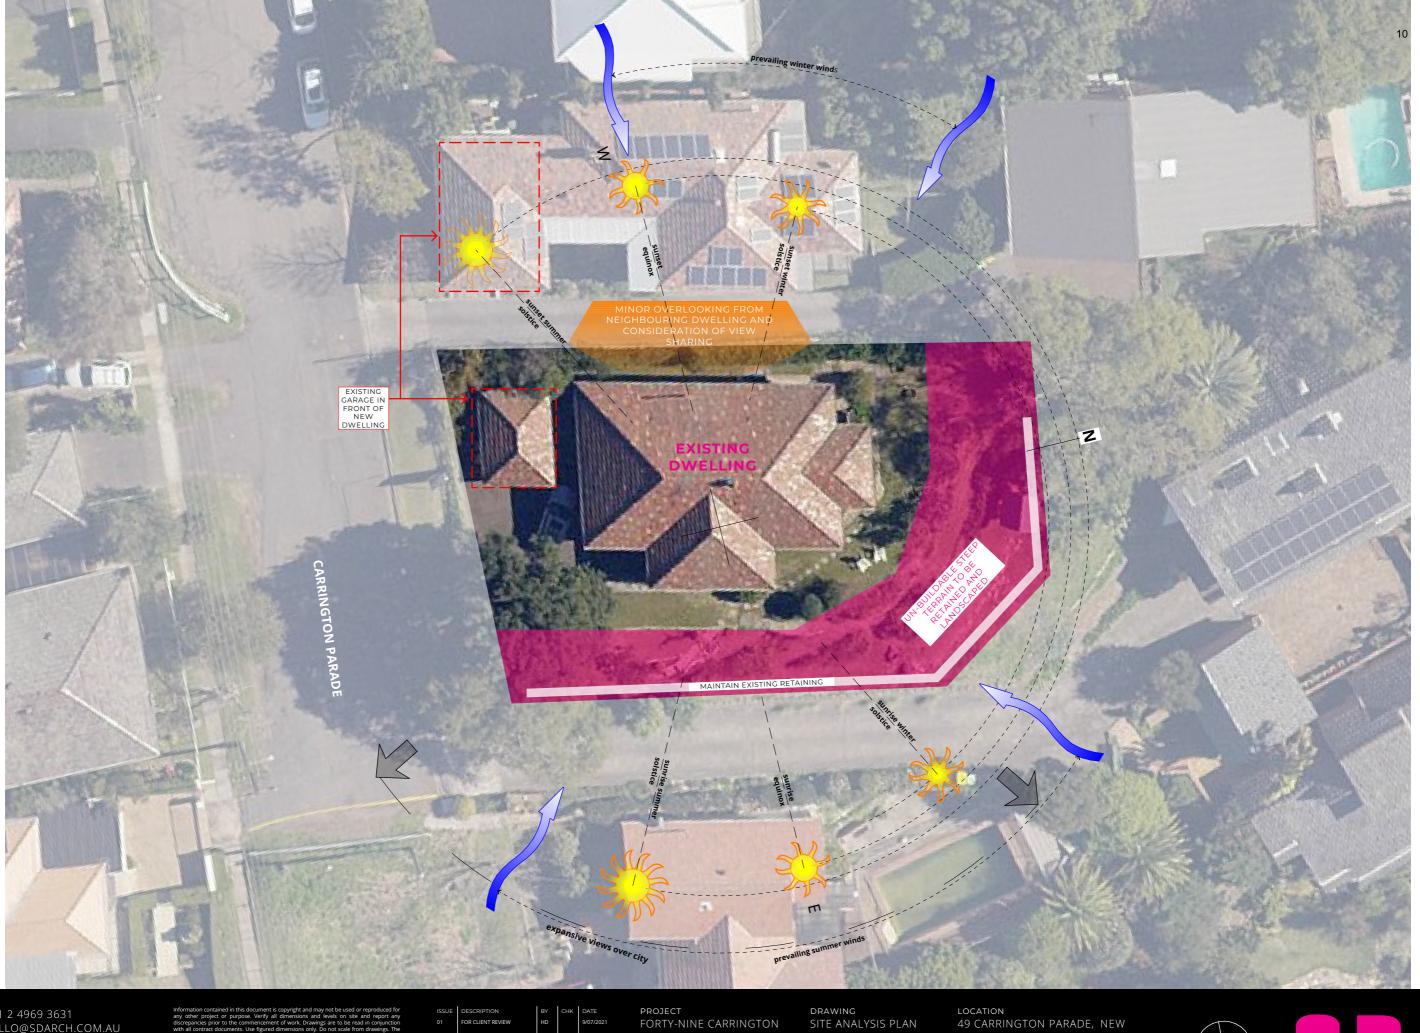

P +61 2 4969 3631
E HELLO@SDARCH.COM.AU
A SUITE 1, LEVEL 1, 187 UNION ST,
THE JUNCTION NSW 2291
SDARCH.COM.AU

CLIENT ARCHIE MORONEY

drawing SITE ANALYSIS PLAN

PROJECT NO. 2020-184

LOCATION 49 CARRINGTON PARADE, NEW LAMBTON, NSW, 2305 drawing no. DD100 ISSUE NO. 03 scale @A3



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CLIENT ARCHIE MORONEY PLAN


PROJECT NO. 2020-184


LAMBTON, NSW, 2305

DRAWING NO. ISSUE NO. SCALE DD102 1:200@A3





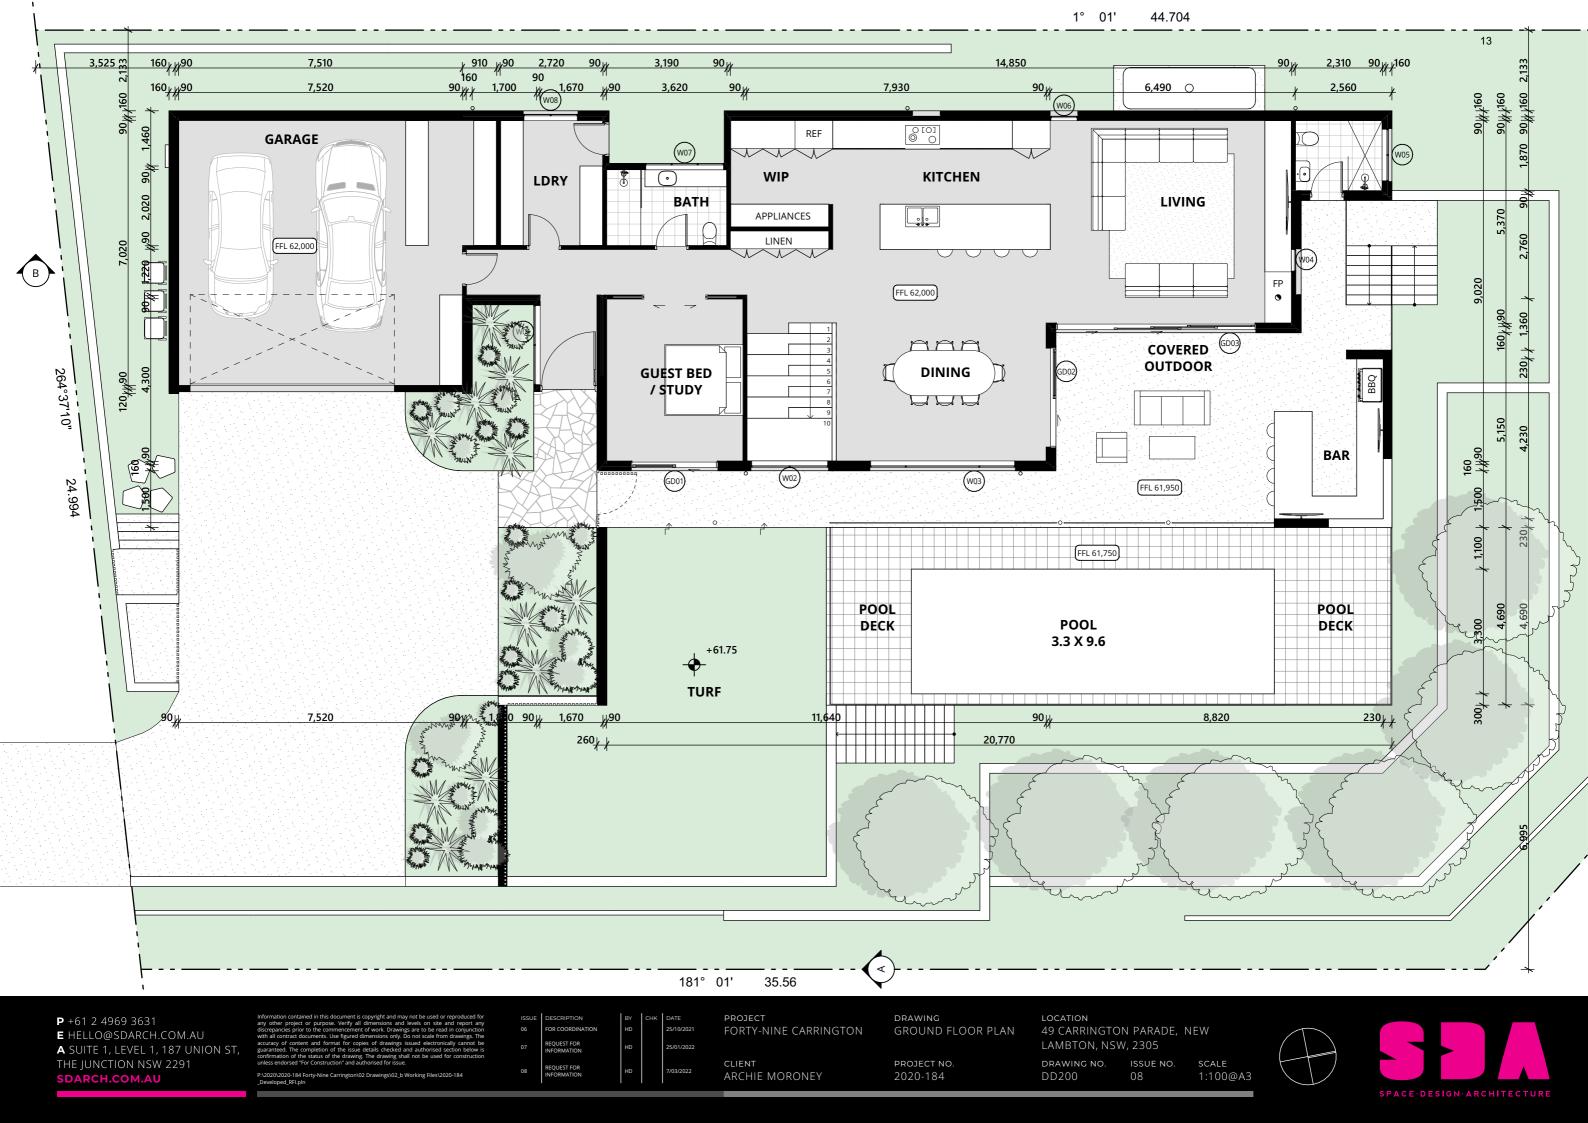

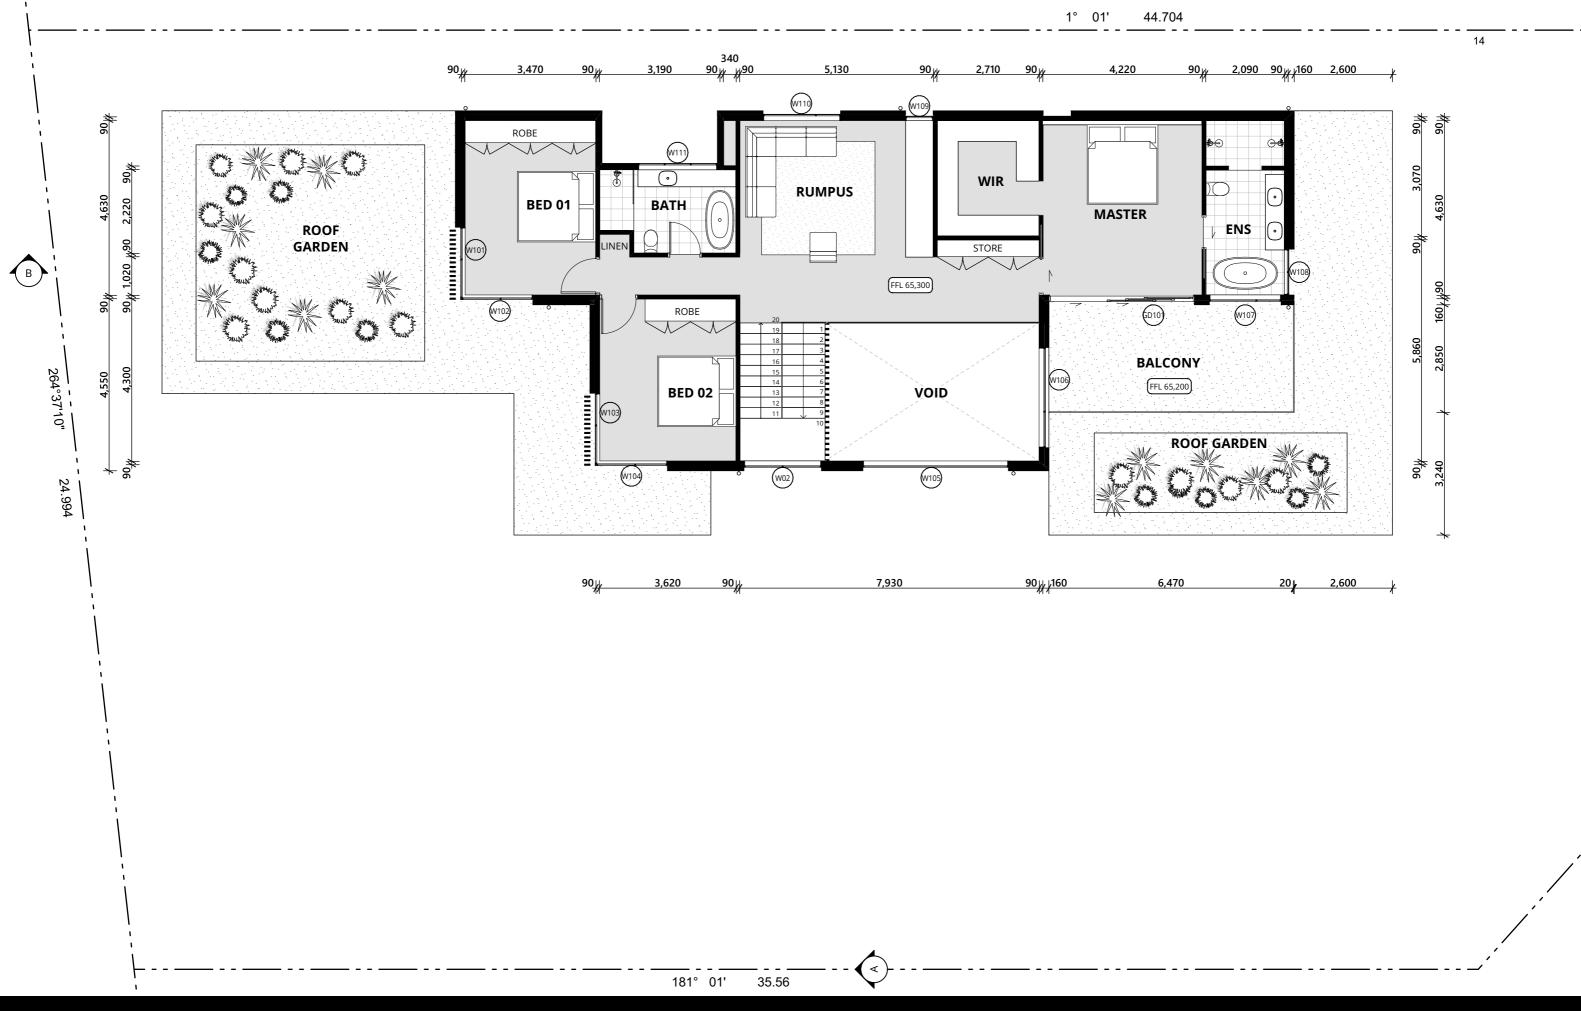

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FORTY-NINE CARRINGTON CLIENT ARCHIE MORONEY

DRAWING FIRST FLOOR PLAN


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LOCATION 49 CARRINGTON PARADE, NEW LAMBTON, NSW, 2305 SCALE 1:100@A3

ISSUE NO. 08 DRAWING NO.





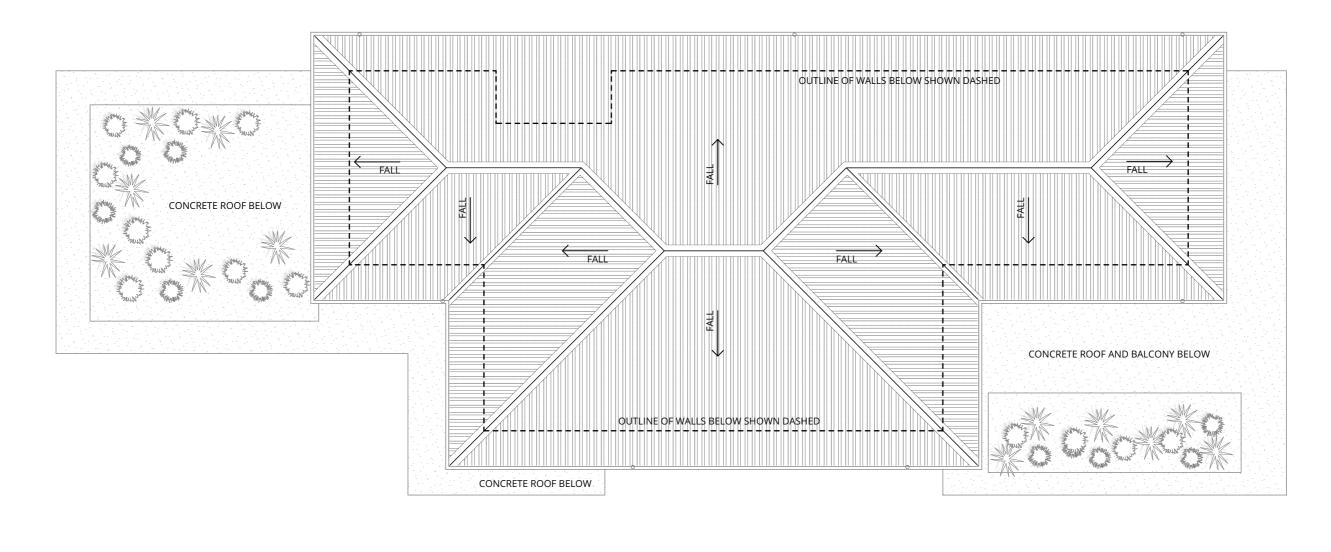

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181° 01'

PROJECT FORTY-NINE CARRINGTON

PROJECT NO. 2020-184

drawing ROOF PLAN

LOCATION 49 CARRINGTON PARADE, NEW LAMBTON, NSW, 2305

drawing no. DD202 issue no. 07





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scale 1:100@A3



AMENDMENTS MADE SINCE LAST REVISION **MATERIALS LEGEND**

LWC1 LIGHTWEIGHT CLADDING

TIMBER CLADDING FB1
FACE BRICKWORK

CONCRETE

STN STONE CLADDING

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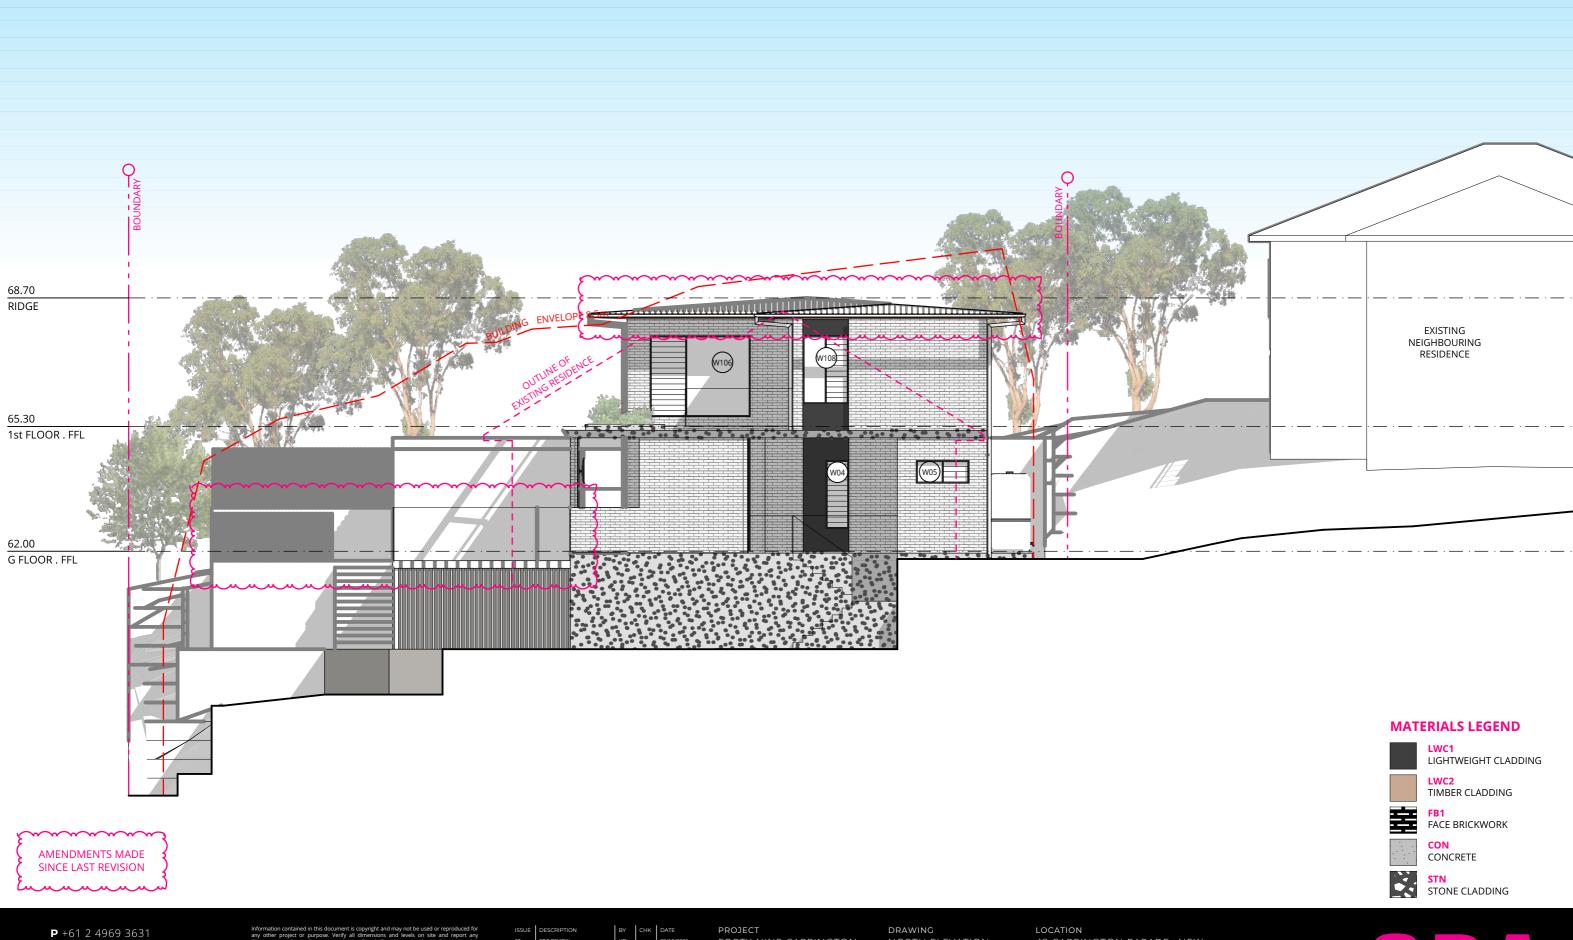
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LOCATION 49 CARRINGTON PARADE, NEW LAMBTON, NSW, 2305

drawing no. DD300 issue no. 07 SCALE 1:100@A3





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PROJECT FORTY-NINE CARRINGTON

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drawing NORTH ELEVATION

PROJECT NO. 2020-184

LOCATION 49 CARRINGTON PARADE, NEW LAMBTON, NSW, 2305

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FORTY-NINE CARRINGTON

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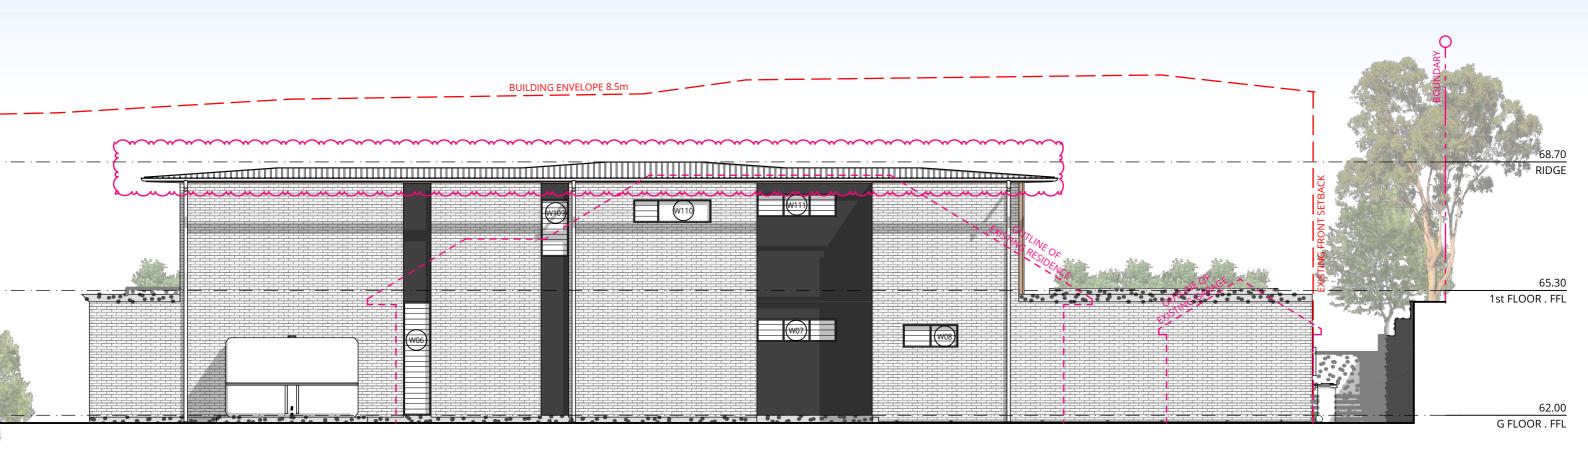
EAST ELEVATION

PROJECT NO. 2020-184

LOCATION 49 CARRINGTON PARADE, NEW LAMBTON, NSW, 2305

drawing no. DD302 ISSUE NO. 07 SCALE 1:100@A3






LWC1 LIGHTWEIGHT CLADDING



MATERIALS LEGEND





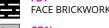



CONCRETE



STN STONE CLADDING

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PROJECT FORTY-NINE CARRINGTON

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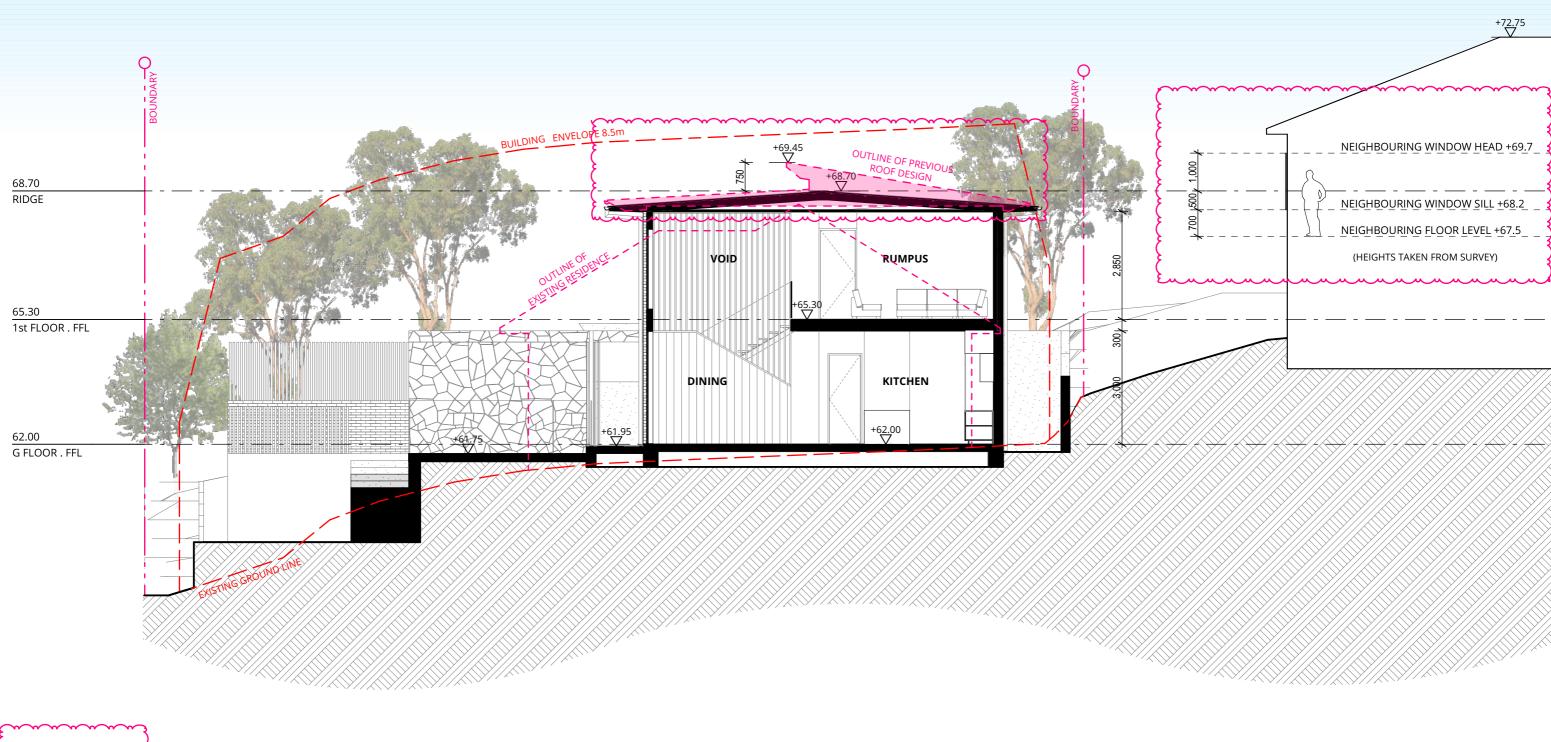
WEST ELEVATION

PROJECT NO. 2020-184

LOCATION 49 CARRINGTON PARADE, NEW LAMBTON, NSW, 2305 SCALE 1:100@A3

drawing no. DD303 issue no. 07





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E HELLO@SDARCH.COM.AU
A SUITE 1, LEVEL 1, 187 UNION ST,
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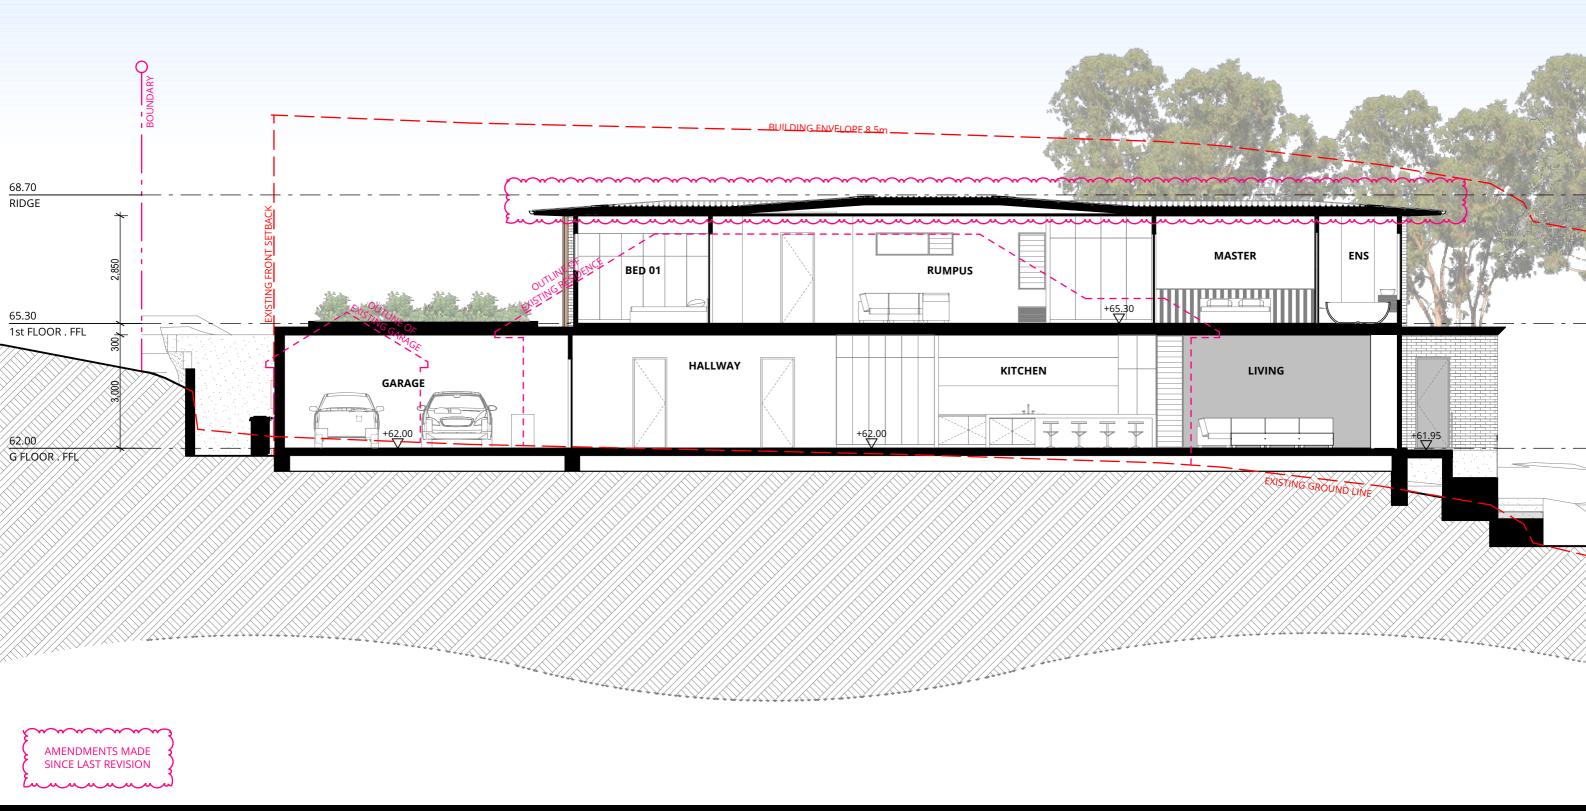
PROJECT
10/2021 FORTY-NINE CARRINGTON
10/2022

ARCHIE MORONEY

drawing SECTION A-A

PROJECT NO. 2020-184 LOCATION
49 CARRINGTON PARADE, NEW
LAMBTON, NSW, 2305
DRAWING NO. ISSUE NO. SCALE
DD400 09 1:100@A3

SPACE-DESIGN-ARCHITECTUR



P +61 2 4969 3631 **E** HELLO@SDARCH.COM.AU A SUITE 1, LEVEL 1, 187 UNION ST, THE JUNCTION NSW 2291 SDARCH.COM.AU

PROJECT FORTY-NINE CARRINGTON

CLIENT ARCHIE MORONEY


drawing SECTION B-B

PROJECT NO. 2020-184

LOCATION 49 CARRINGTON PARADE, NEW LAMBTON, NSW, 2305

drawing no. DD401 issue no. 07 scale 1:100@A3



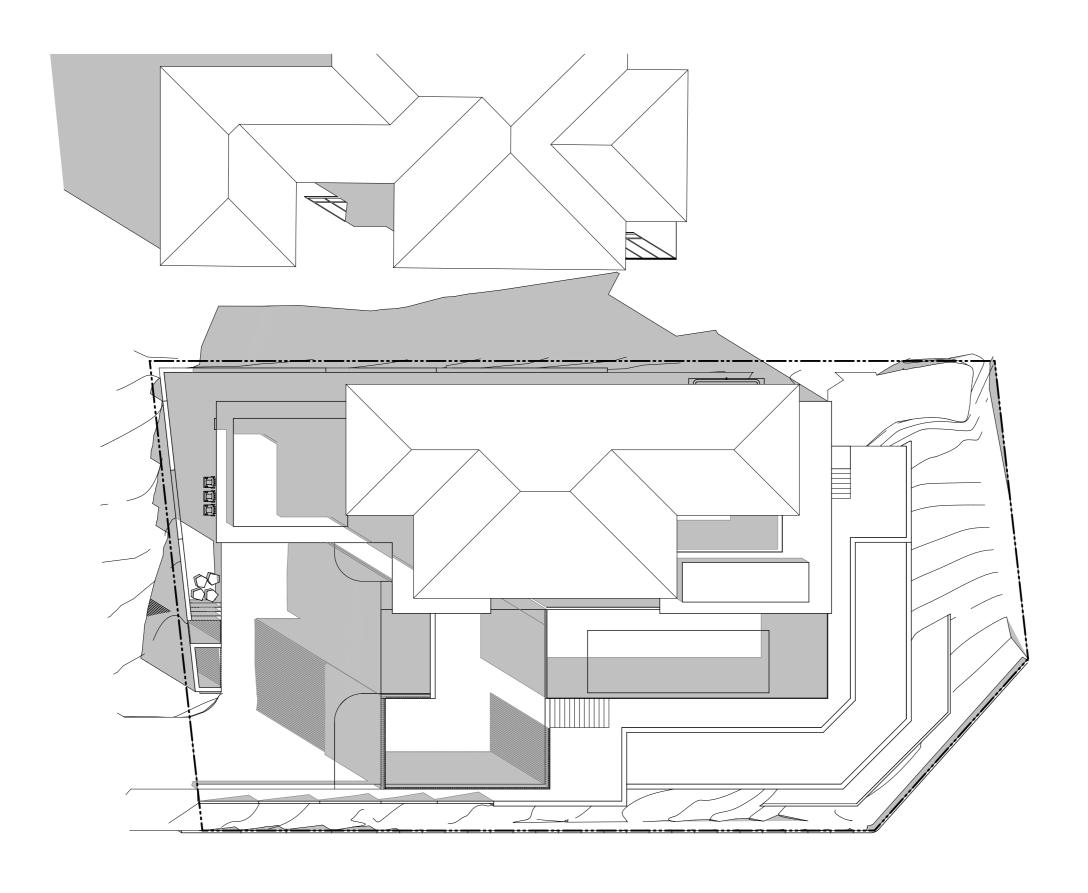



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PROJECT FORTY-NINE CARRINGTON

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drawing SHADOW DIAGRAMS -PROJECT NO. 2020-184


LOCATION 49 CARRINGTON PARADE, NEW LAMBTON, NSW, 2305 issue no. 05


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scale 1:200@A3







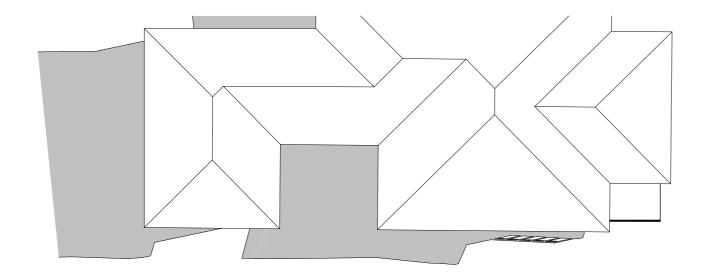

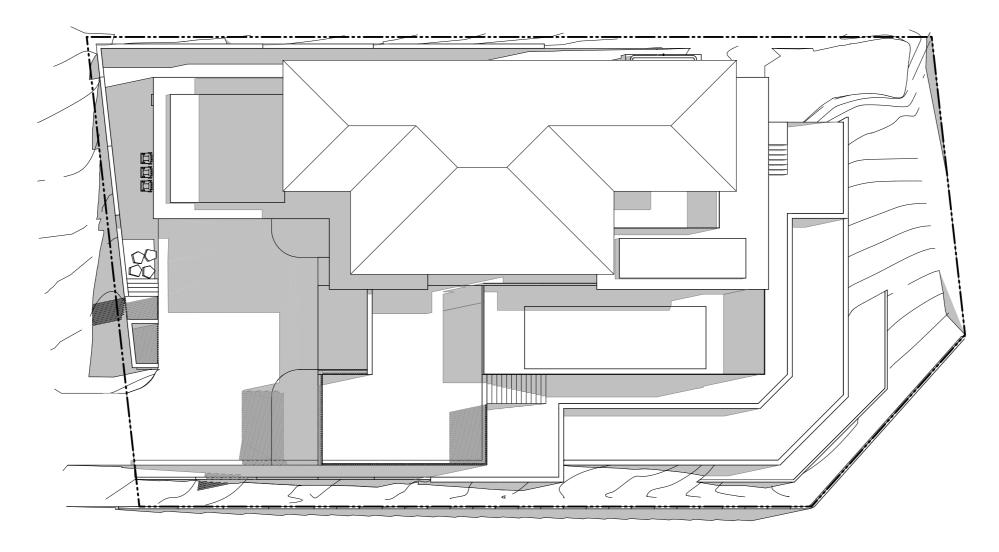21 JUN at 1200h SCALE 1:200

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PROJECT FORTY-NINE CARRINGTON

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drawing SHADOW DIAGRAMS -SHEET 2 PROJECT NO. 2020-184


LOCATION 49 CARRINGTON PARADE, NEW LAMBTON, NSW, 2305 issue no. 05

drawing no. DD501

scale 1:200@A3





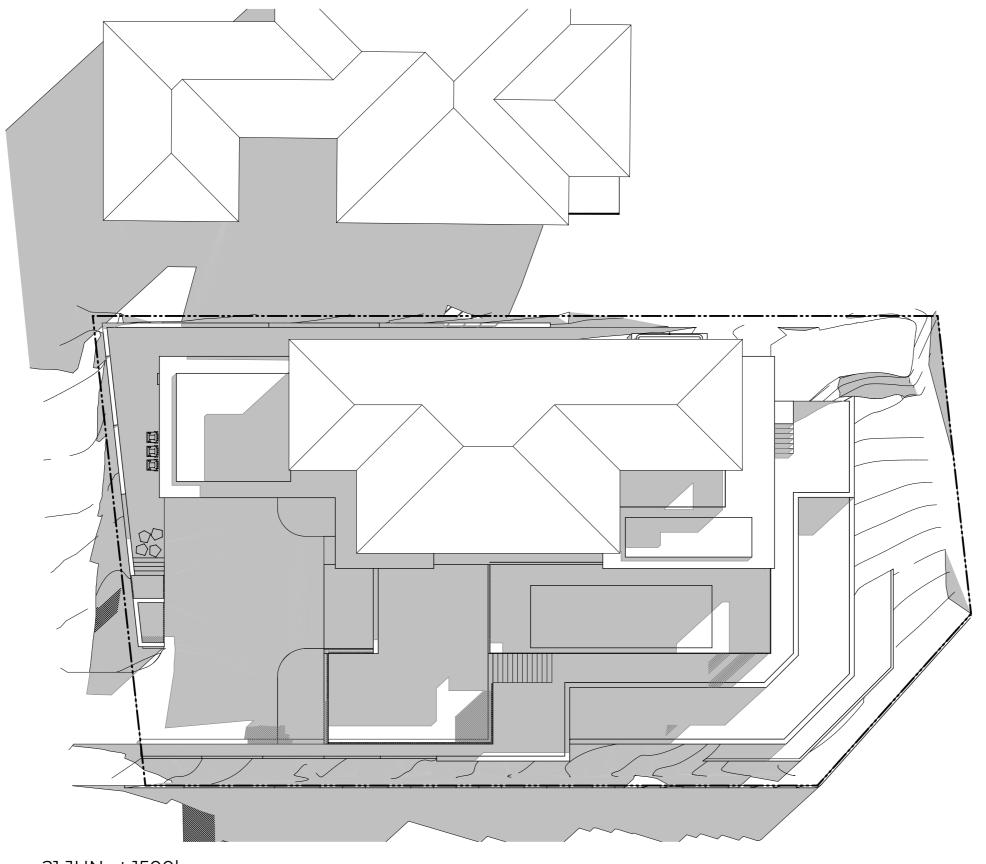

21 JUN at 1500h SCALE 1:200

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PROJECT FORTY-NINE CARRINGTON

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drawing SHADOW DIAGRAMS -SHEET 3

PROJECT NO. 2020-184


LOCATION 49 CARRINGTON PARADE, NEW LAMBTON, NSW, 2305

drawing no. DD502

ISSUE NO. 05 scale 1:200@A3





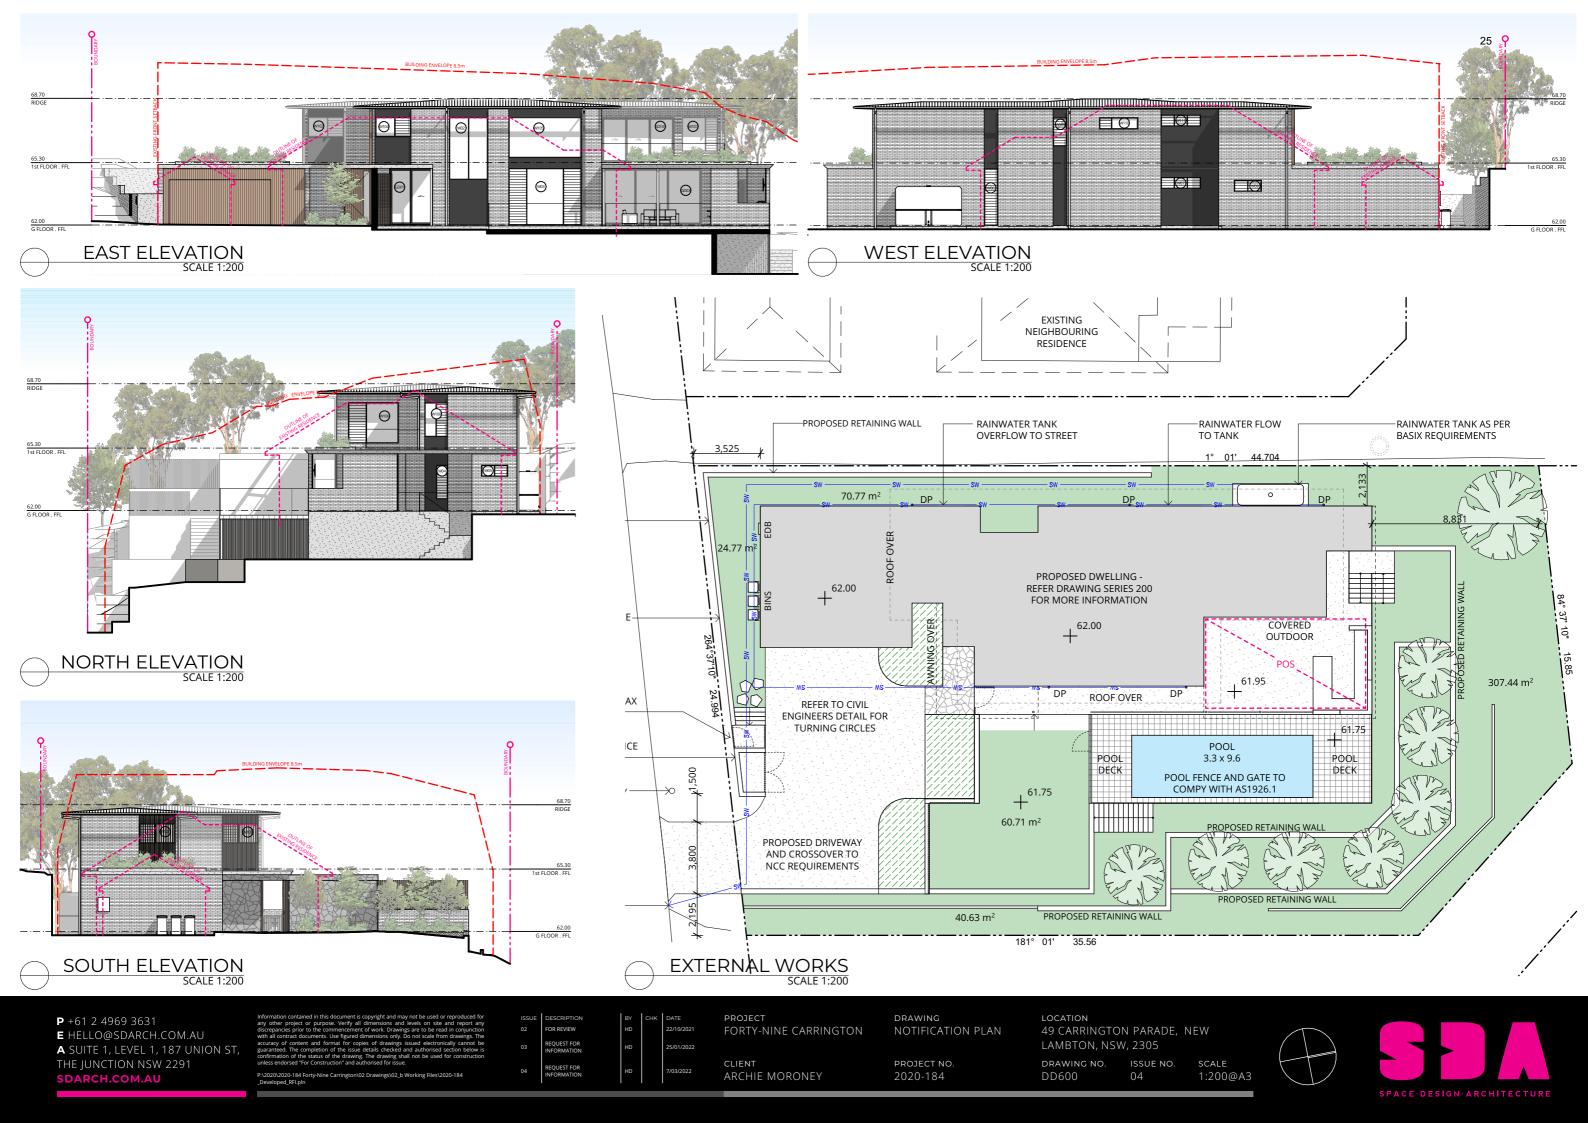










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ISSUE	DESCRIPTIO
	REQUEST FOR INFORMATION
02	REQUEST FOR







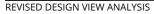

REVISED DESIGN VIEW ANALYSIS



ORIGINAL DESIGN (IMAGES PREPARED BY DNF PLANNERS AS PART OF SUBMISSION)



ORIGINAL DESIGN (IMAGES PREPARED BY DNF PLANNERS AS PART OF SUBMISSION)

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E HELLO@SDARCH.COM.AU
A SUITE 1, LEVEL 1, 187 UNION ST,
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REQUEST FOR INFORMATION

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PROJECT FORTY-NINE CARRINGTON

CLIENT ARCHIE MORONEY DRAWING VIEW ANALYSIS - SHEET 02

PROJECT NO. 2020-184 LOCATION 49 CARRINGTON PARADE, NEW LAMBTON, NSW, 2305

DRAWING NO. ISSUE NO. SCALE DD701 01 @A3








ORIGINAL DESIGN (IMAGES PREPARED BY DNF PLANNERS AS PART OF SUBMISSION)



REVISED DESIGN VIEW ANALYSIS

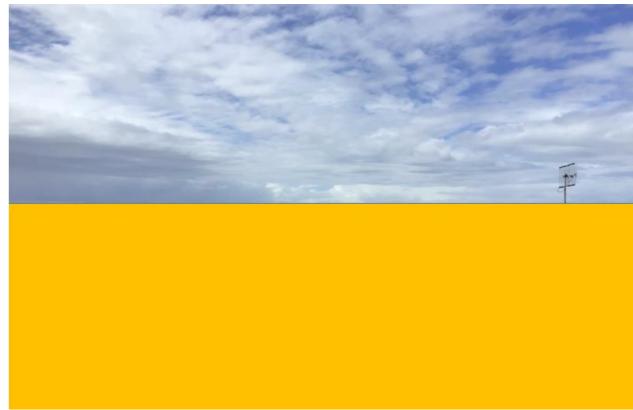

ORIGINAL DESIGN (IMAGES PREPARED BY DNF PLANNERS AS PART OF SUBMISSION)

P +61 2 4969 3631
E HELLO@SDARCH.COM.AU
A SUITE 1, LEVEL 1, 187 UNION ST,
THE JUNCTION NSW 2291
SDARCH.COM.AU

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PROJECT FORTY-NINE CARRINGTON

CLIENT ARCHIE MORONEY DRAWING VIEW ANALYSIS - SHEET 03

03 project no. 2020-184 LOCATION
49 CARRINGTON PARADE, NEW
LAMBTON, NSW, 2305

DRAWING NO. ISSUE NO. SCALE
DD702 01 @A3






REVISED DESIGN VIEW ANALYSIS

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REVISED DESIGN VIEW ANALYSIS



ORIGINAL DESIGN (IMAGES PREPARED BY DNF PLANNERS AS PART OF SUBMISSION)

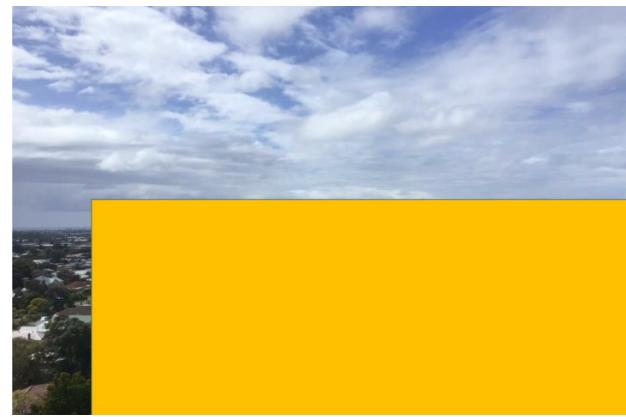

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P +61 2 4969 3631
E HELLO@SDARCH.COM.AU
A SUITE 1, LEVEL 1, 187 UNION ST,
THE JUNCTION NSW 2291
SDARCH.COM.AU

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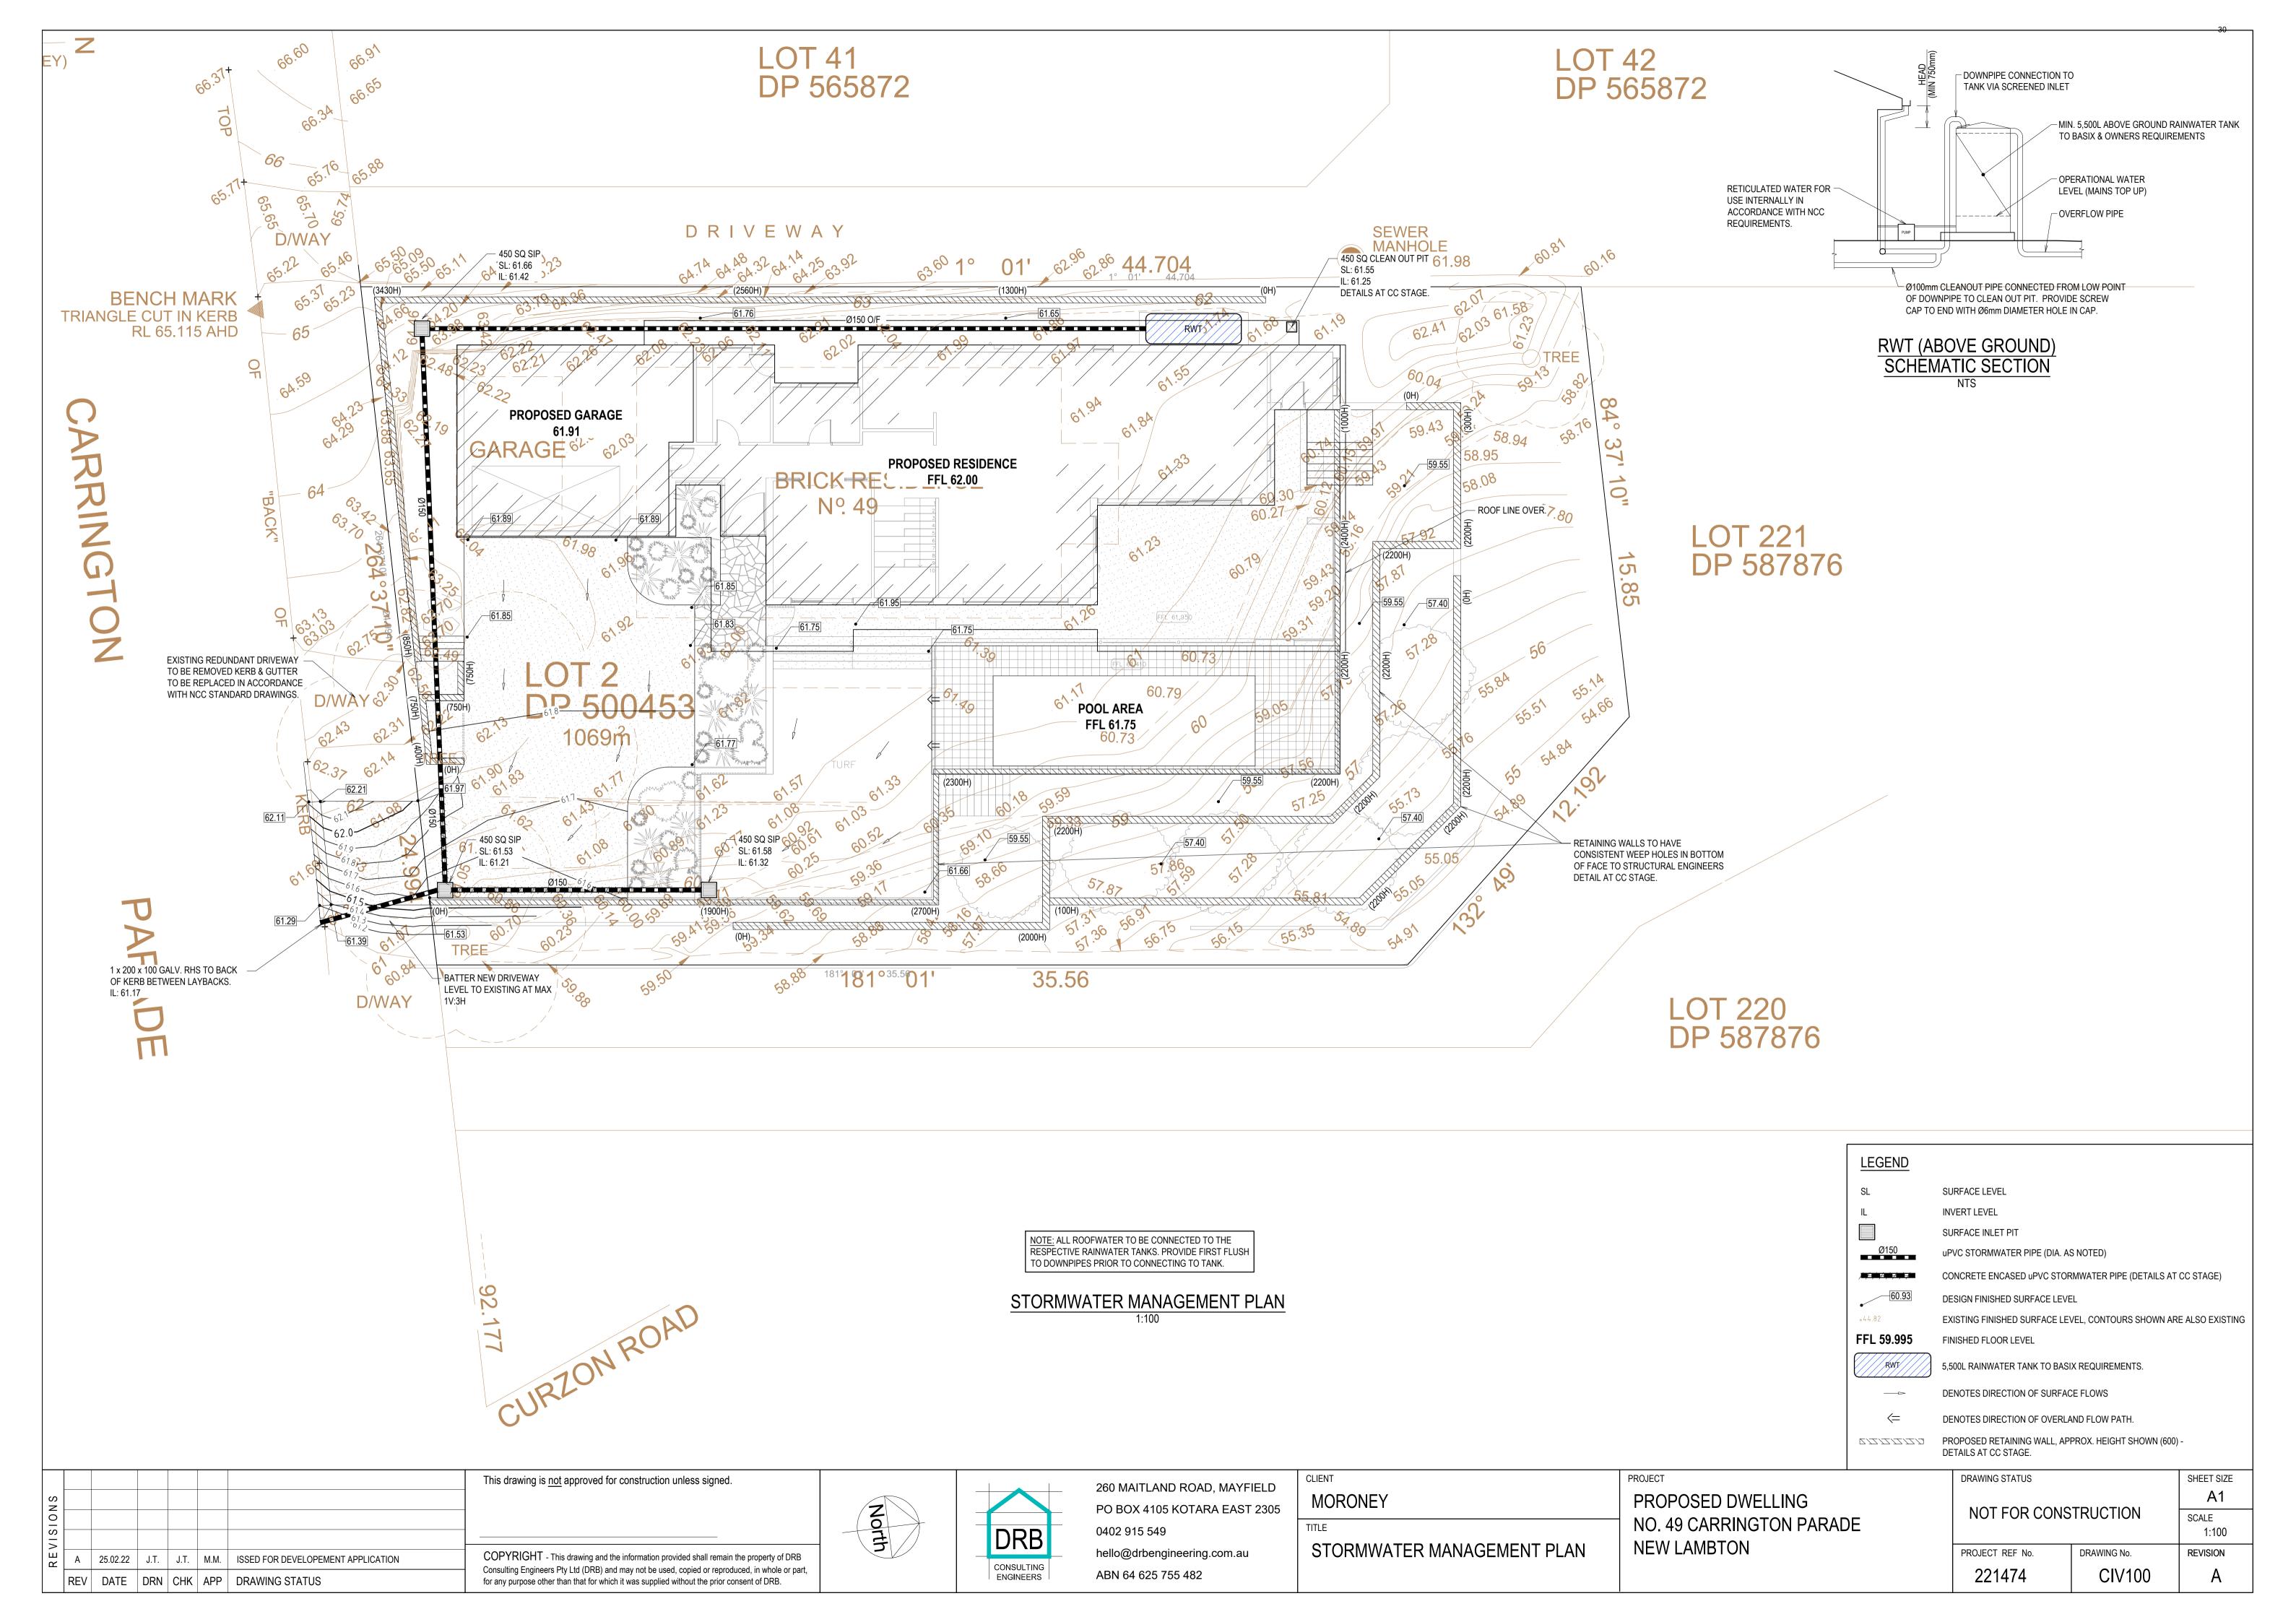
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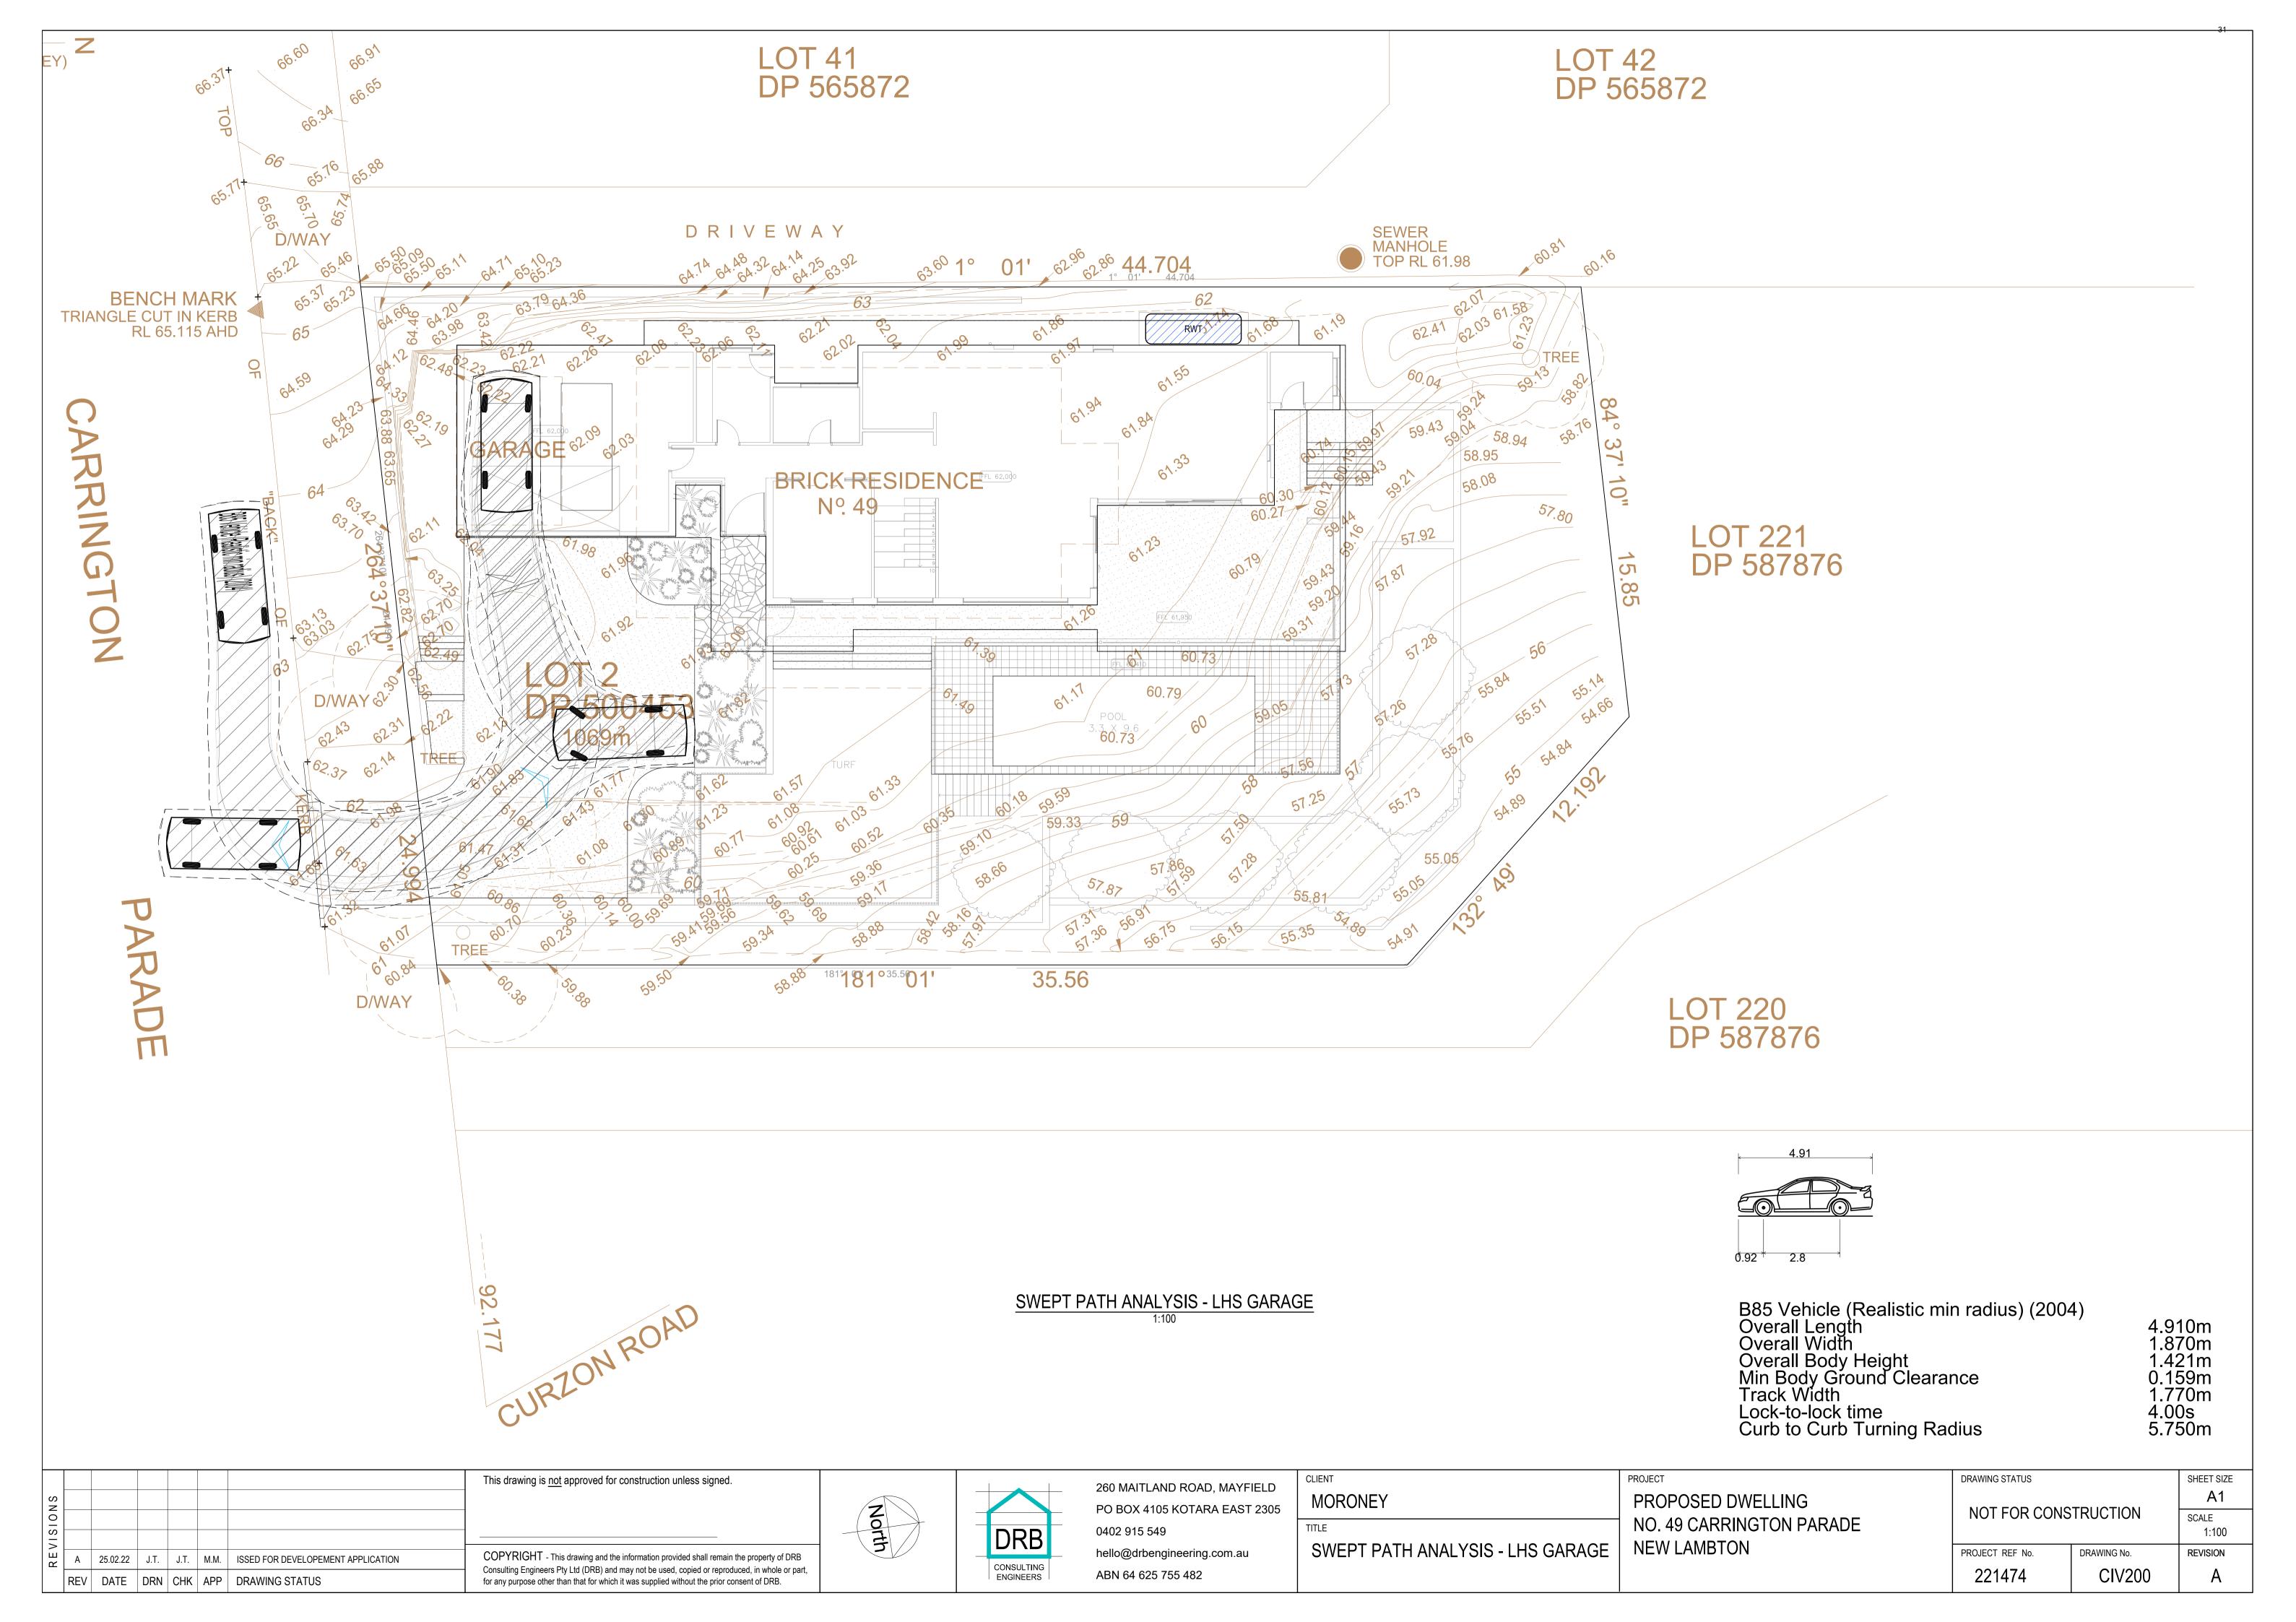
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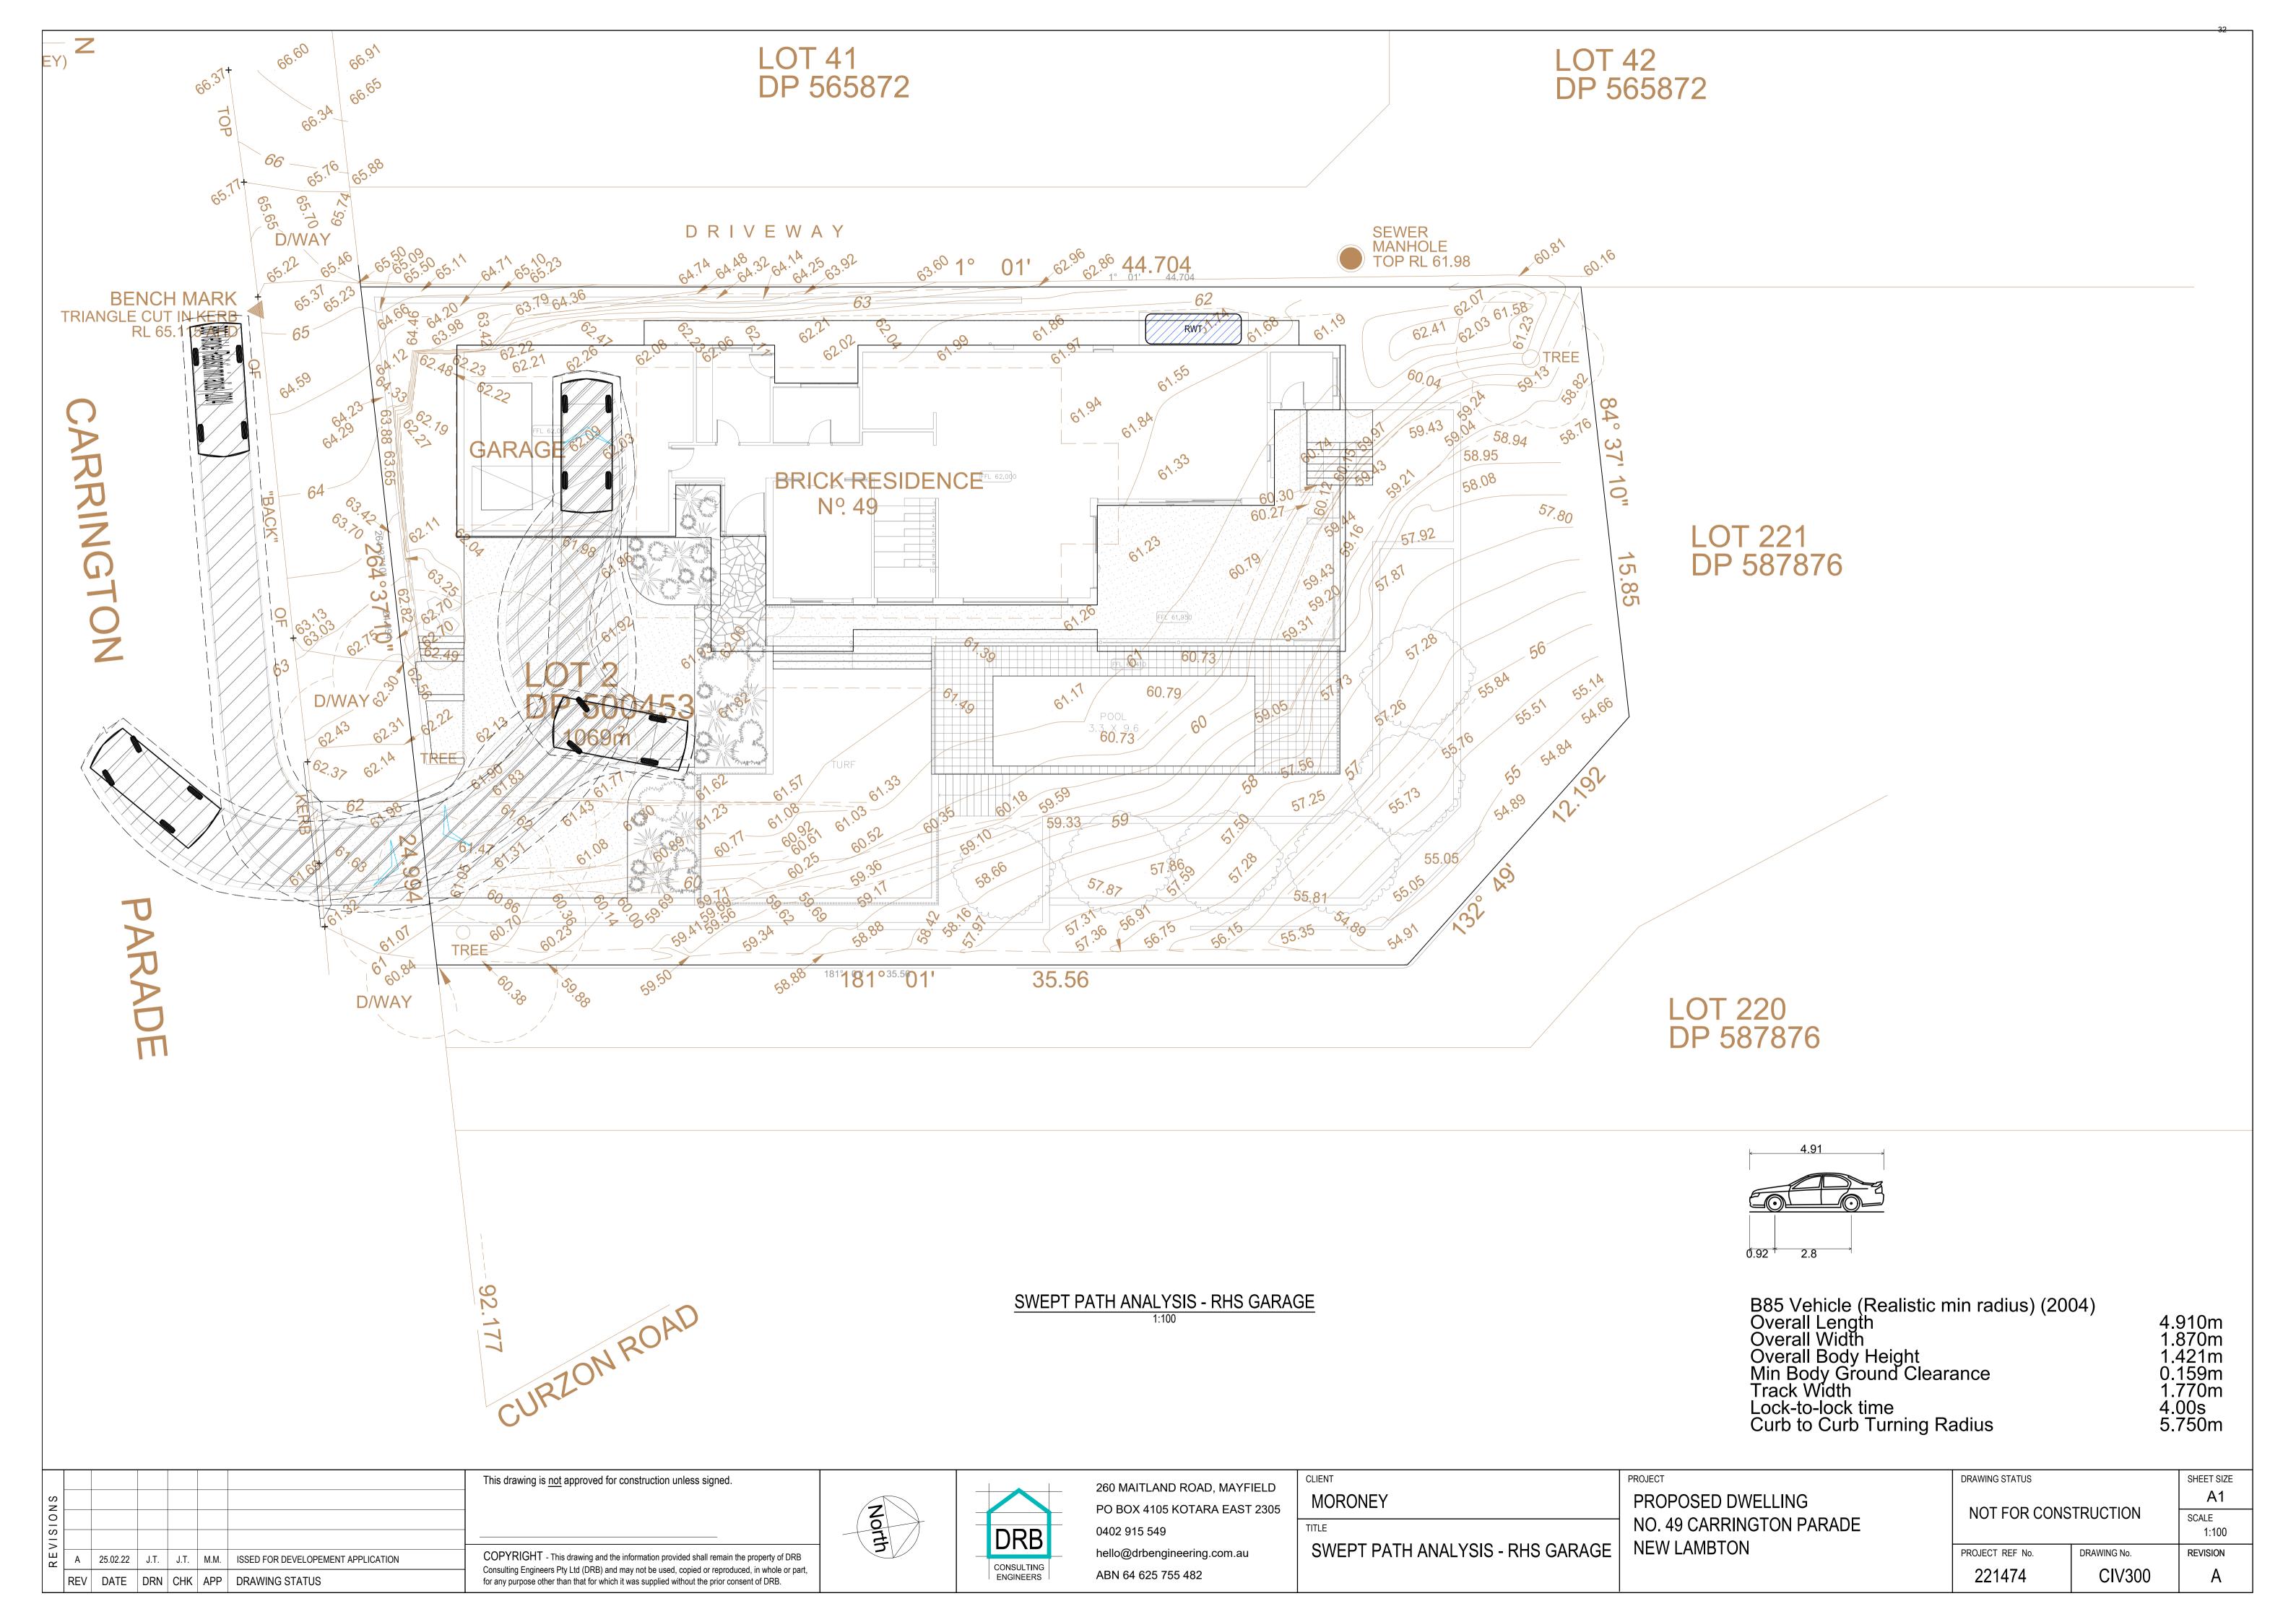
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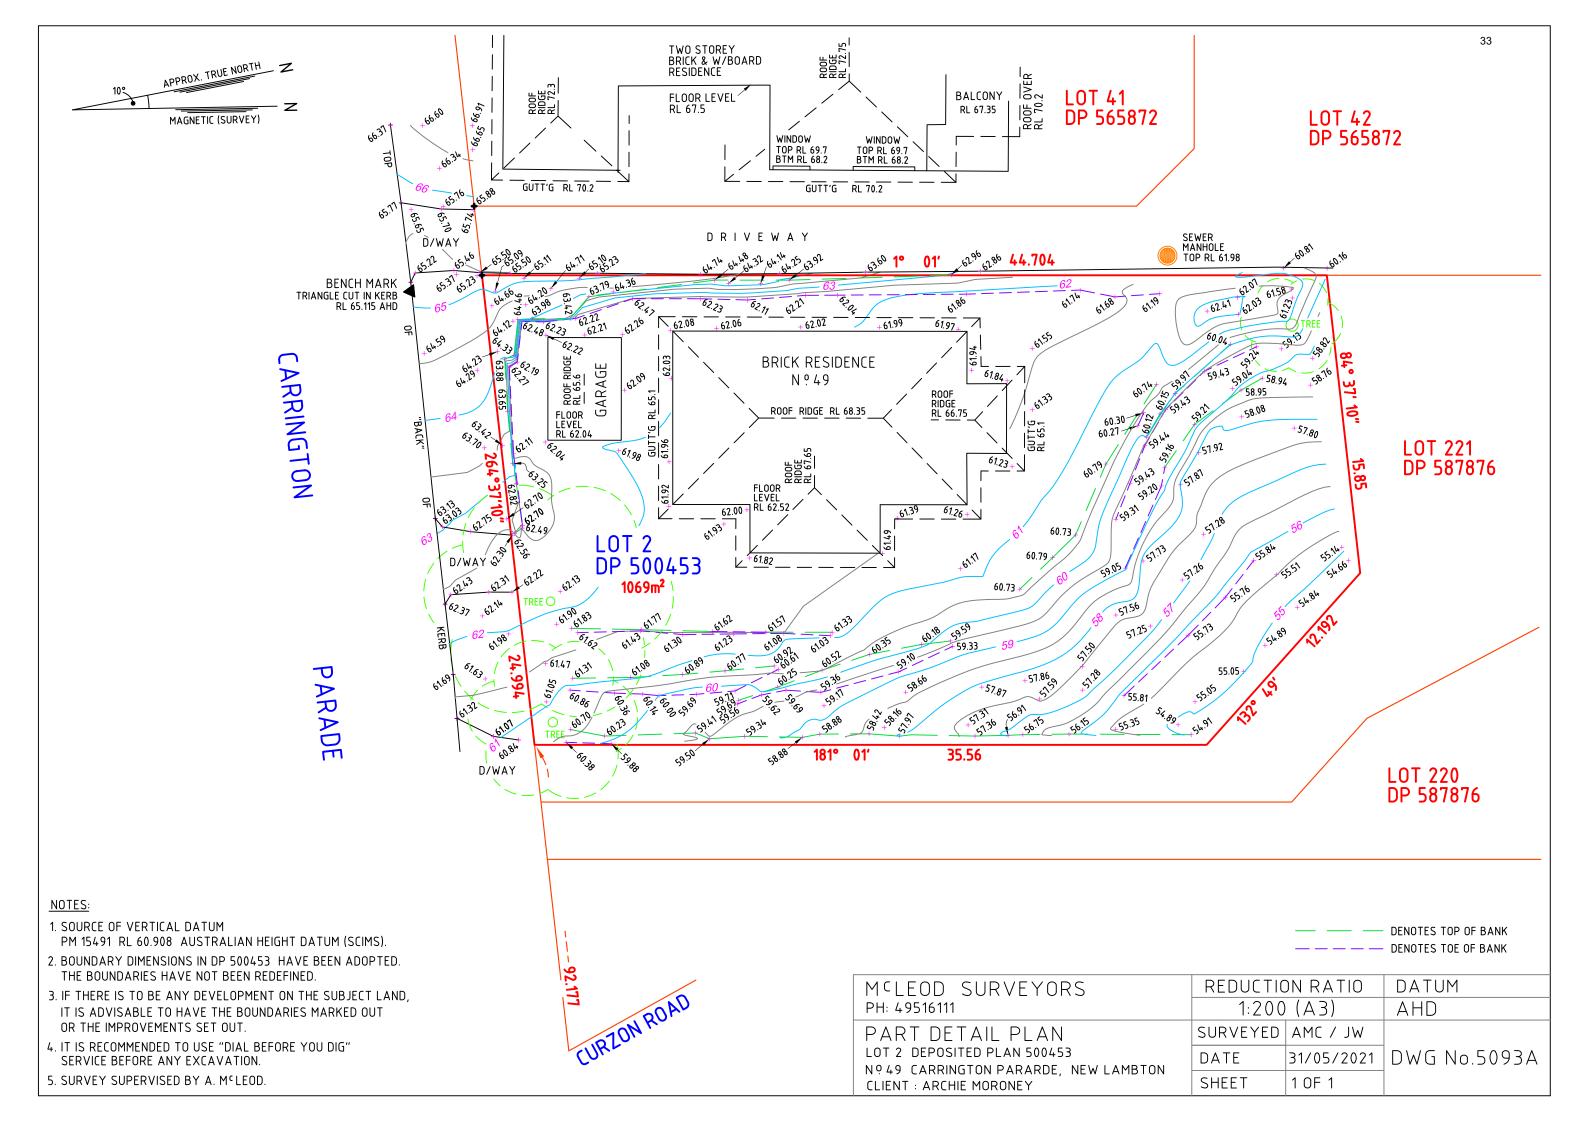
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49 CARRINGTON PARADE, NEW
LAMBTON, NSW, 2305
DRAWING NO. ISSUE NO. SCALE
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ATTACHMENTS DISTRIBUTED UNDER SEPARATE COVER

PV 16/08/22 - 49 CARRINGTON PARADE, NEW LAMBTON -DA2021/01185 - DWELLING HOUSE - DEMOLITION OF EXISTING STRUCTURES AND ERECTION OF TWO STOREY HOUSE INCLUDING ANCILLARY DEVELOPMENT (POOL AND RETAINING WALLS)

ITEM-1 Attachment B: Views Analysis



ABN 23 104 067 405

7 Canberra Street PO Box 850 Charlestown NSW 2290

P 02 4942 5441 F 02 4942 5301

E admin@dewittconsulting.com.au

www.dewittconsulting.com.au

7 March 2022

OUR REF: 12826

YOUR REF: DA2021/01185

The General Manager
City of Newcastle
12 Stewart Avenue
NEWCASTLE WEST NSW 2300

ATTENTION: GORDON EDGAR (Email: gedgar@ncc.nsw.gov.au)

Dear Gordon,

RE: DA2021/01185 – 49 CARRINGTON PARADE, NEW LAMBTON NSW 2305

Further information is provided in response to City of Newcastle's request for a View Impact Assessment (VIA). This was requested within Council's request for information (RFI) letter dated 10 December 2021. This VIA has been prepared with regard to the proposed development application (DA) for a dwelling house on land known as 49 Carrington Parade, New Lambton NSW 2305 (Lot 2 DP500453) (the site).

1. VIEW ANALYSIS

View sharing is invoked when a property enjoys existing views and a proposed development would share that view by taking some of it away for its own enjoyment. Section 3.02.09 of Newcastle Development Control Plan (DCP) 2012 includes the following performance criteria and acceptable solution for view sharing:

Performance criteria

- 1. Development is designed to allow view sharing with neighbouring properties.
- 2. Design plans identify existing views and demonstrate how view sharing is achieved.
- 3. Important public views and vistas are to be enhanced by the form and treatment of buildings including roof scapes.

Acceptable Solutions

1. The building height does not exceed 5m or if the building is over 5m adjoining properties do not have views or vistas to water, city skyline and iconic views obscured by the proposed development.

Note: Merit based proposals (that do not meet acceptable solutions) must address the performance criteria having regards to the planning principle for view sharing established by the NSW Land and Environment Court (Tenacity Consulting Vs Warringah Council (2004))

The Amended Architectural Plans at **Appendix 1** show that the proposed dwelling has been significantly reduced in height to that which was originally submitted as part of DA2021/01185. Specifically, the ridgeline has been reduced by 750mm in an attempt to improve the relationship with adjoining development, particularly in regard to views. The proposed dwelling now displays a maximum building height that is well contained within the maximum 8.5m height limit prescribed for the site. The maximum height (above existing ground level) is noted as 8.1m and this is owed to the change in ground level and slope at site. The maximum height from finished floor level to ridgeline has been minimised where possible and is represented as 6.7m.



Notwithstanding the above amendments, the proposed development does exceed 5m and will still therefore require an assessment of the view sharing principals contained in the NSW Land and Environment Court (Tenacity Consulting Vs Warringah Council (2004)). This VIA considers that the revised design will not unreasonably obscure views from adjoining properties, particularly No. 53 Carrington Parade.

Importantly, the proposal has considered the planning principals set out in the aforementioned case law, which established a four-step process for considering the impact of a development on views.

- i. An assessment of the value of views to be affected by reference to their nature, extent and completeness.
- ii. A consideration of how views are obtained and what part of the property the views are obtained from.
- iii. A qualitative assessment of the extent of the impact in terms of severity particularly as to whether that impact is negligible, minor, moderate, severe or devastating.
- iv. An assessment of the reasonableness of the proposal causing the impact particularly in terms of compliance with applicable planning controls and whether a different or complying design must produce a better result. Where an impact on views arises as a result of non-compliance with one or more planning controls, even a moderate impact may be considered unreasonable.

These are addressed below as part of this VIA.

i. 'The first step is the assessment of views to be affected'. Water views are valued more highly than land views. Iconic views (e.g. of the Opera House, the Harbour Bridge or North Head) are valued more highly than views without icons. Whole views are valued more highly than partial views, e.g. a water view in which the interface between land and water is visible is more valuable than one in which it is obscured."

Views from No. 53 Carrington Parade are characterised as being land views, obtained via the side boundary (east). The existing views are partial, interrupted views across the suburban plain. These land views are already interrupted by the existing dwelling at No. 53 Carrington Parade, as well as existing vegetation on their own property and on adjoining properties. Views also include distant and interrupted glimpses of water. It should be highlighted that the ocean shoreline is in excess of 7 kilometres to the east and separated by urban sprawl. These views are shown in *Photos 1-6 below.* It's also relevant to note that the dwelling at No. 53 Carrington Parade would benefit from additional land views of the suburban plain to the north, which are not in the line of the proposed development.

Note that these photos have been taken from the submission prepared on behalf of the property owners at No. 53 Carrington Parade. No details/confirmation have been provided to the Applicant confirming where these photos have been obtained from, with their location redacted from the submission. As such, we have made several assumptions based on a best guess and review of available information. Should we be advised otherwise, we would update our assessment as required.

Furthermore, the Council RFI letter requests that views from No's 51 and 55 Carrington Parade are also considered. Based on the available information, views from No. 51 Carrington Parade would not be obtained across their eastern boundary across an area that would be affected by the proposal. They are located further north of the site and their living areas and areas of open space are located to the rear (even further north) and would not be orientated toward the subject property. Therefore, we do not consider any further assessment of their views necessary. Similarly, views from No. 55 Carrington Parade would not be impacted by the proposed development. As seen from the building sections, the proposed dwelling would be obscured from view by the existing dwelling at No. 53 Carrington Parade, being 4.05m below the ridgeline of that dwelling. No. 55 Carrington Parade is located much further upslope and it is not expected their views are impacted. Therefore we do not consider any further assessment of their views necessary.

ii. 'The second step is to consider from what part of the property the views are obtained'. For example the protection of a view across side boundaries is more difficult than the protection of views from the front and rear boundaries. In addition, whether the view is enjoyed from a standing or sitting position may also be relevant. Sitting views are more difficult to protect than standing views. The expectation to retain side views and sitting views is often unrealistic."

Views from No. 53 Carrington Parade are shown in *Photos 1-6* below. Photomontages showing the outline of the existing development and the proposed development also provided (reproduced from **Appendix 2**).



<u>Photo 1 Comment (below)</u>: This view is obtained via the garage window, looking east across the property's side boundary. It is unrealistic for the property owners to expect that a side view can be retained, particularly one obtained via an inhabitable room. Furthermore, the value of this view is substantially reduced by existing vegetation, both on the property and adjoining property.



Photo 1 and 1.1: Existing view looking east from the garage window above and photomontage below.





<u>Photo 2 Comment (below)</u>: This view is obtained via a small balcony adjoining the garage, looking east across the property's side boundary. Similarly, it is unrealistic to retain side boundary views, particularly one that is obtained from an area that is so infrequently used (we would assume based on its size and location adjoining a garage). Importantly, Photo 2 highlights that this view is already interrupted by the existing dwelling ridgeline and existing vegetation on both properties.



Photo 2 and 2.1: Existing view looking east from the small balcony adjoining the garage and photomontage below.





<u>Photo 3 Comment (below)</u>: This view is obtained via the side boundary, looking east from a small balcony adjoining the opposite wall (further north) from the balcony in Photo 2. Again, the view is obtained via the side boundary and substantially interrupted by the existing dwelling and vegetation at No. 49 Carrington Parade. While the proposed dwelling offers a different built form and shape, the extent of the overall footprint is substantially the same.



Photo 3 and 3.1: Existing view looking east from the small balcony and photomontage below.





<u>Photo 4 Comment (below)</u>: This view is obtained via the side boundary, looking from an internal living area. We have not been able to confirm where this view has been taken from – the view may be from a kitchen, which in that case the view is more highly valued. Notwithstanding, this view is still obstructed by the existing dwelling on No. 49 Carrington Parade.



Photo 4 and 4.1: Existing view looking east from a window from a living area and photomontage below.





<u>Photo 5 Comment (below):</u> This view is obtained via the side boundary, looking from the rear verandah, which we would assume forms the private open space for the dwelling at No. 53 Carrington Parade. This side view is interrupted by the existing dwelling at No. 49 Carrington Parade. Distant and interrupted glimpses of water are visible in the background



Photo 5 and 5.1: Existing view looking east from the rear verandah and photomontage below.





<u>Photo 6 Comment:</u> This view is taken from the backyard, being significantly lower in elevation than the raised rear verandah/living spaces. This view is obtained from the side boundary and is substantially interrupted by vegetation on their own site (large hedging), as well as the existing dwelling at No. 49 Carrington Parade.



Photo 6: Existing view looking east from the backyard and photomontage below.





<u>Conclusion</u>: All views are obtained across the property's side boundary and already substantially interrupted by the existing dwelling at No. 49 Carrington Parade and existing vegetation on both properties. While it is acknowledged that the most favourable views from No. 53 Carrington Parade are those obtained to the east, the expectation to retain side boundary views is still unrealistic. Furthermore, it must be acknowledged that the new proposed development, whilst it does create an altered impact on views, does not create a new impact on available views.

iii. 'The third step is to assess the extent of the impact'. This should be done for the whole of the property, not just for the view that is affected. The impact on views from living areas is more significant than from bedrooms or service areas (though views from kitchens are highly valued because people spend so much time in them). The impact may be assessed quantitatively, but in many cases this can be meaningless. For example, it is unhelpful to say that the view loss is 20% if it includes one of the sails of the Opera House. It is usually more useful to assess the view loss qualitatively as negligible, minor, moderate, severe or devastating."

Having consideration for the existing land views, impacts observed by the existing dwelling at No. 49 Carrington Parade, impacts from existing vegetation on and off site, that the views are obtained entirely across the side boundary from less than desirable locations such as the garage, rear yard and small service balconies – but with due consideration given to the more valuable views from internal living areas and the rear POS – the extent of the proposed built form is considered to have an overall *minor to moderate impact*.

iv. 'The fourth step is to assess the reasonableness of the proposed development that is causing the impact'. A development that complies with all planning controls would be considered more reasonable than one that breaches them. Where an impact on views arises as a result of non-compliance with one or more planning controls, even a moderate impact may be considered unreasonable. With a complying proposal, the question should be asked whether a more skilful design could provide the applicant with the same development potential and amenity and reduce the impact on views of neighbours. If the answer to that question is no, then the view impact of a complying development would probably be considered acceptable and the view sharing reasonable."

The proposed development complies with all principle development standards applicable to the site. The maximum height (above existing ground level) is noted as 8.1m and this is owed to the change in ground level and slope at site. The maximum height from finished floor level to ridgeline has been minimised where possible and is represented as 6.7m. The proposed dwelling also displays a floor space ratio (FSR) significantly below that which has been prescribed for the site. Referring to numerical development controls, the proposed dwelling displays a high level of compliance with the Newcastle Development Control Plan (DCP) with regards to site setbacks, site coverage and landscaping. The proposal displays a good relationship with adjoining properties with regards to privacy, overshadowing and based on this assessment, does allow for view sharing.

In the absence of any non-compliances with planning controls, the question is then asked – could a more skilful design be provided? We would suggest that a more skilful design has already been provided as part of this submission back to Council (acknowledging that the original plans did display some non-compliances to Council planning controls – i.e. building height). The proposal proposes a *minor to moderate impact* on views and complies with Council's planning controls, including principle development standards.

The principles of view sharing are again emphasised. Yes, the property owners at No. 53 Carrington Parade do enjoy views from their property, however, they do not have a legal, proprietary right to maintain or protect those views from their home. The very concept of view sharing is that when a property enjoys existing views, a proposed development would share this view by taking some of it away for their own enjoyment. It's also noted that the proposed development does not propose to take away the complete views from No. 53 Carrington Parade, with many of these views already obscured by existing development / vegetation.

Having regard to the four steps of the planning principle of Tenacity, the view sharing impact is found to be *acceptable* and the view sharing is *reasonable*.



2. CONCLUSION

Home owners do not have a proprietary right to a view (all or part of that view) from their land and even devastating view loss is considered reasonable in some circumstances. The proposed development proposes to share the views currently enjoyed by adjoining properties, particularly at No. 53 Carrington Parade.

We trust the information provided throughout this response letter will enable your ongoing assessment of the DA.

Should you have any other queries in relation to the development, please do not hesitate to contact the undersigned on 0456 650 713.

de Witt Consulting

Liberty PannowitzTOWN PLANNER

Appendix 1 – Amended Architectural Plans

Appendix 2 – Detail Survey